


CLIENT/PROJECT  
**SNRG 307**  
**Computer Aided Design 1**  
**House Design Project**

PROJECT SEMESTER PROJECT	DATE 13 / 12 / 2012
DRAWN Murat Kinaci	APPROVED

SHEET TITLE  
**Front Elevation**

Scale: 1 : 60

SHEET  
**E-1-13**

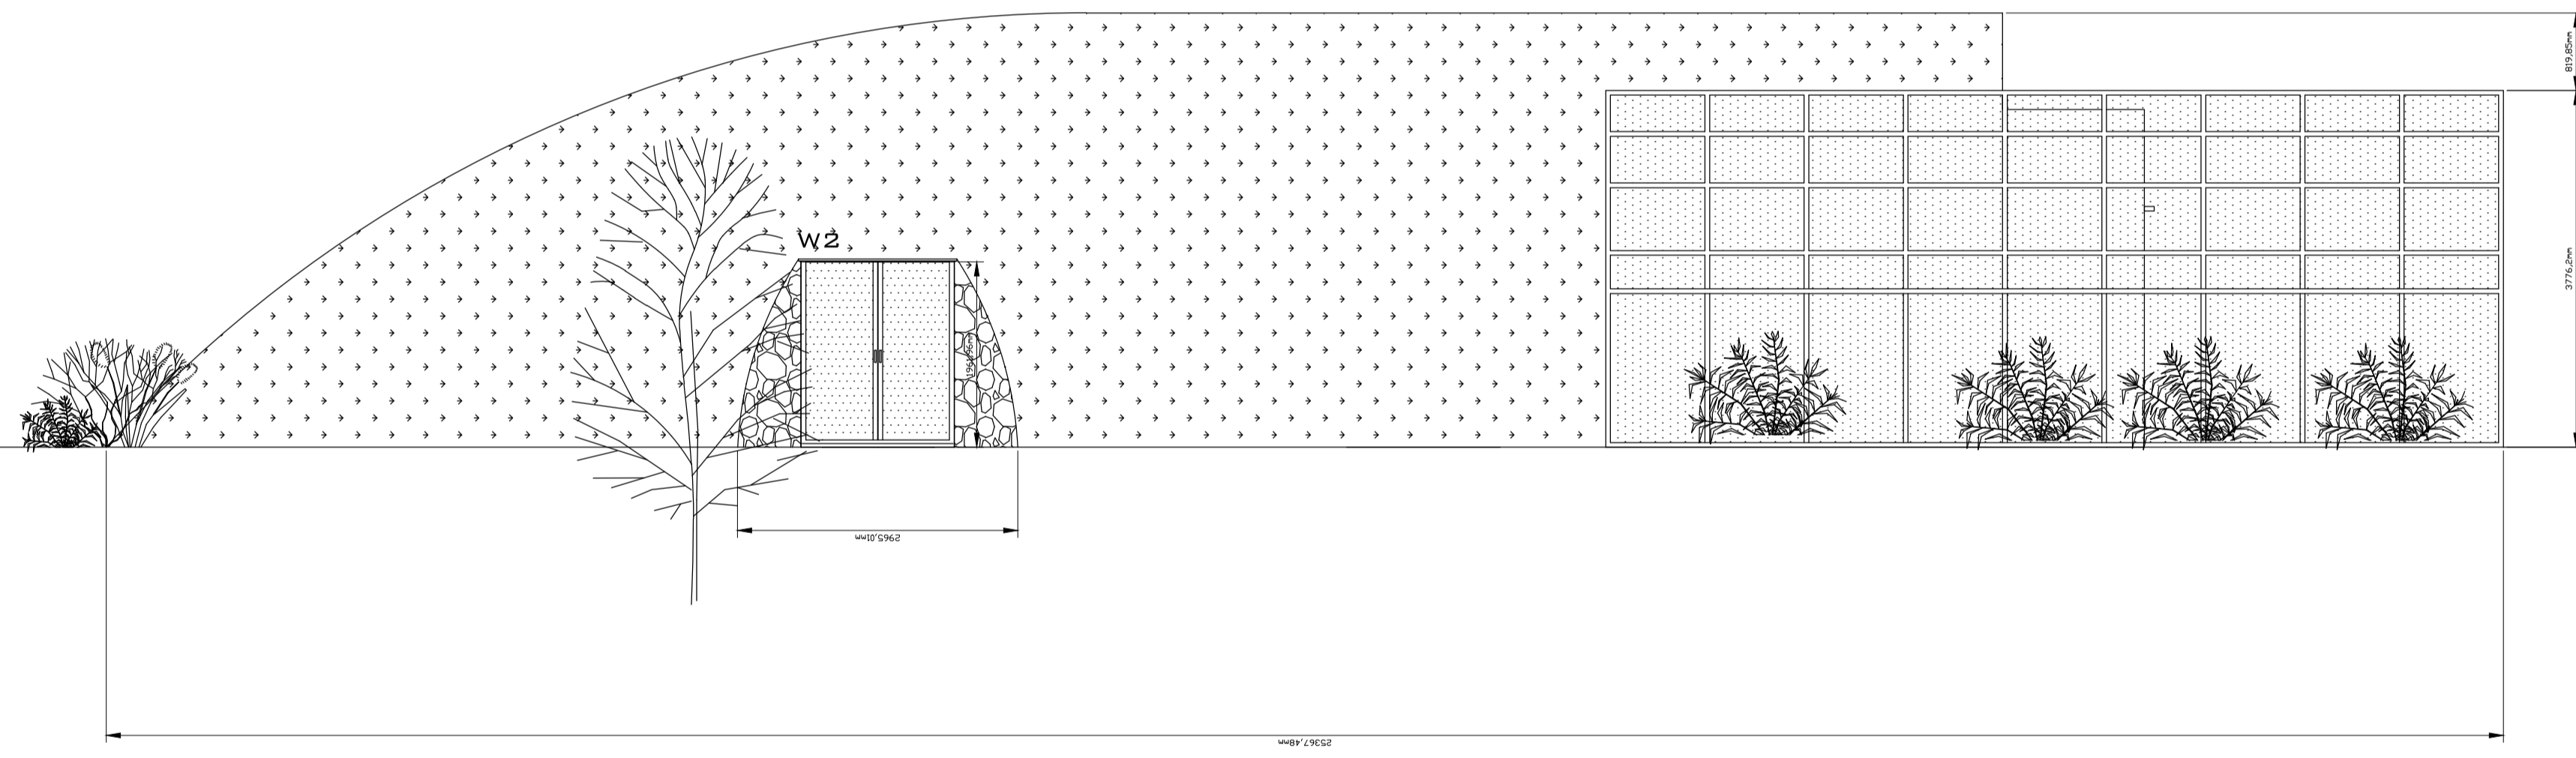

CLIENT/PROJECT

**SNRG 307**  
**Computer Aided Design 1**  
**House Design Project**

PROJECT	DATE
SEMESTER PROJECT	13 / 12 / 2012


DRAWN	APPROVED
Murat Kinaci	

SHEET TITLE

**West Elevation**

**Scale: 1 : 60**

SHEET **E-2-13**

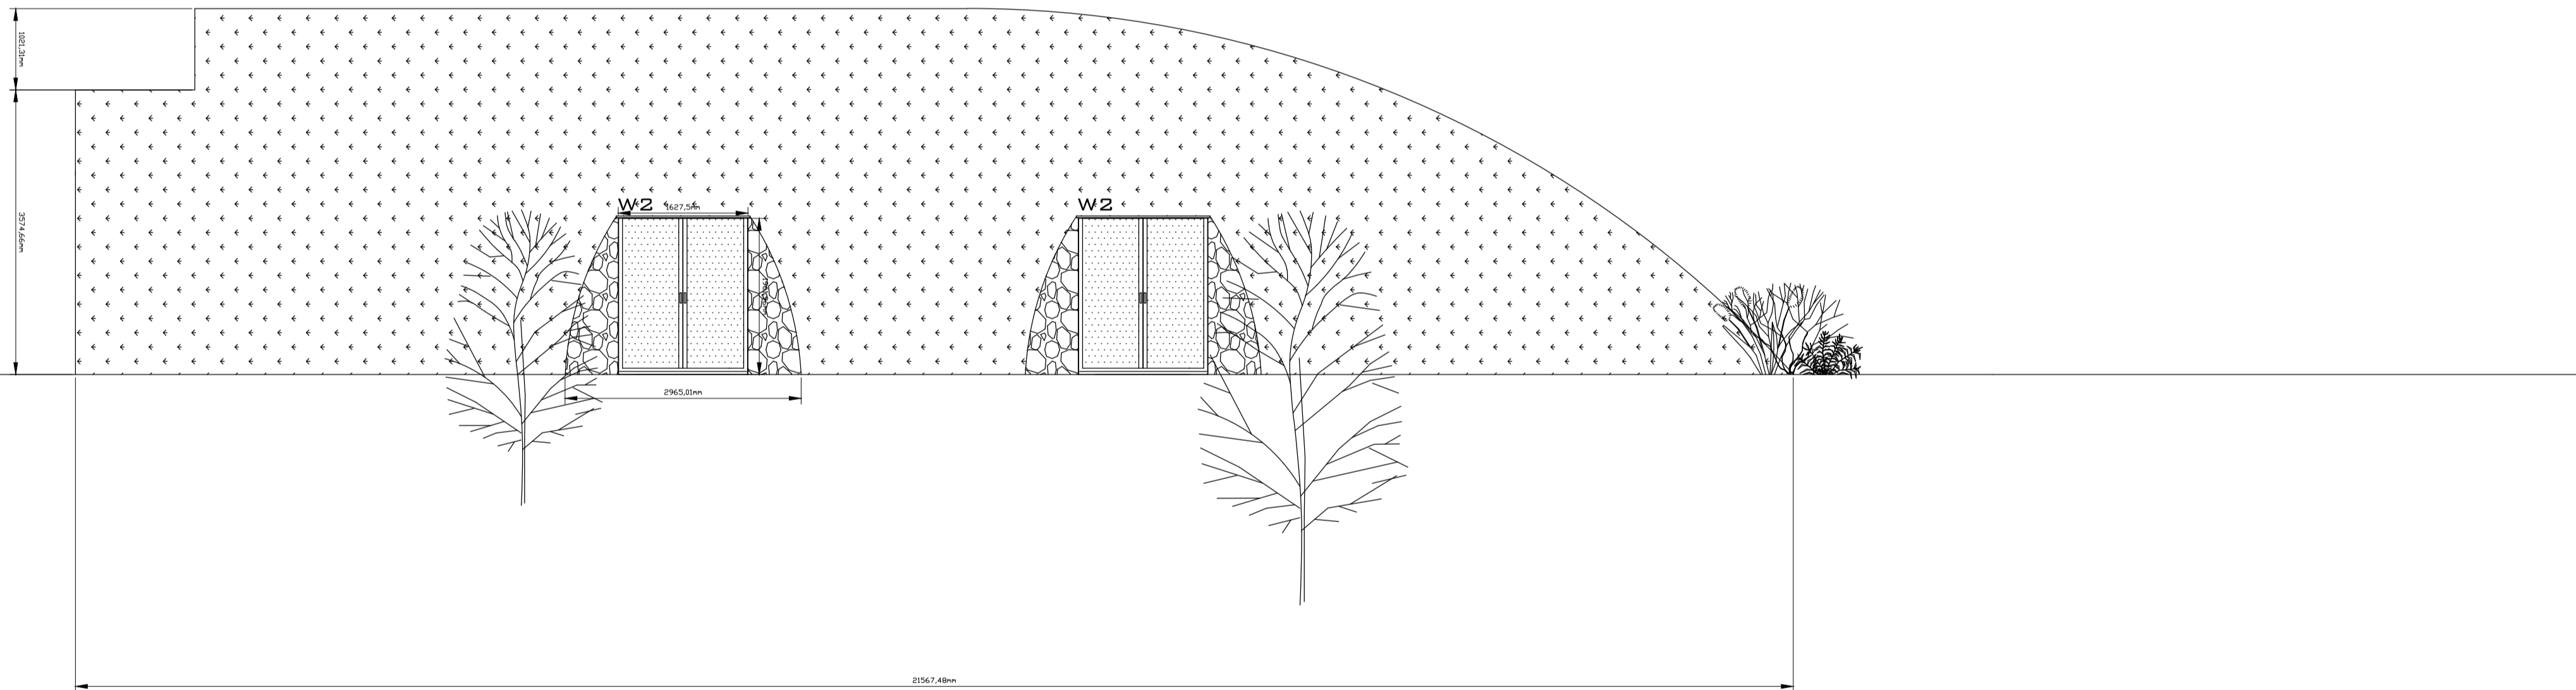

CLIENT/PROJECT

**SNRG 307**  
**Computer Aided Design 1**  
**House Design Project**

PROJECT	DATE
SEMESTER PROJECT	13 / 12 / 2012


DRAWN	APPROVED
Murat Kinaci	

SHEET TITLE

**East Elevation**

Scale: 1 : 60

SHEET **E-3-13**

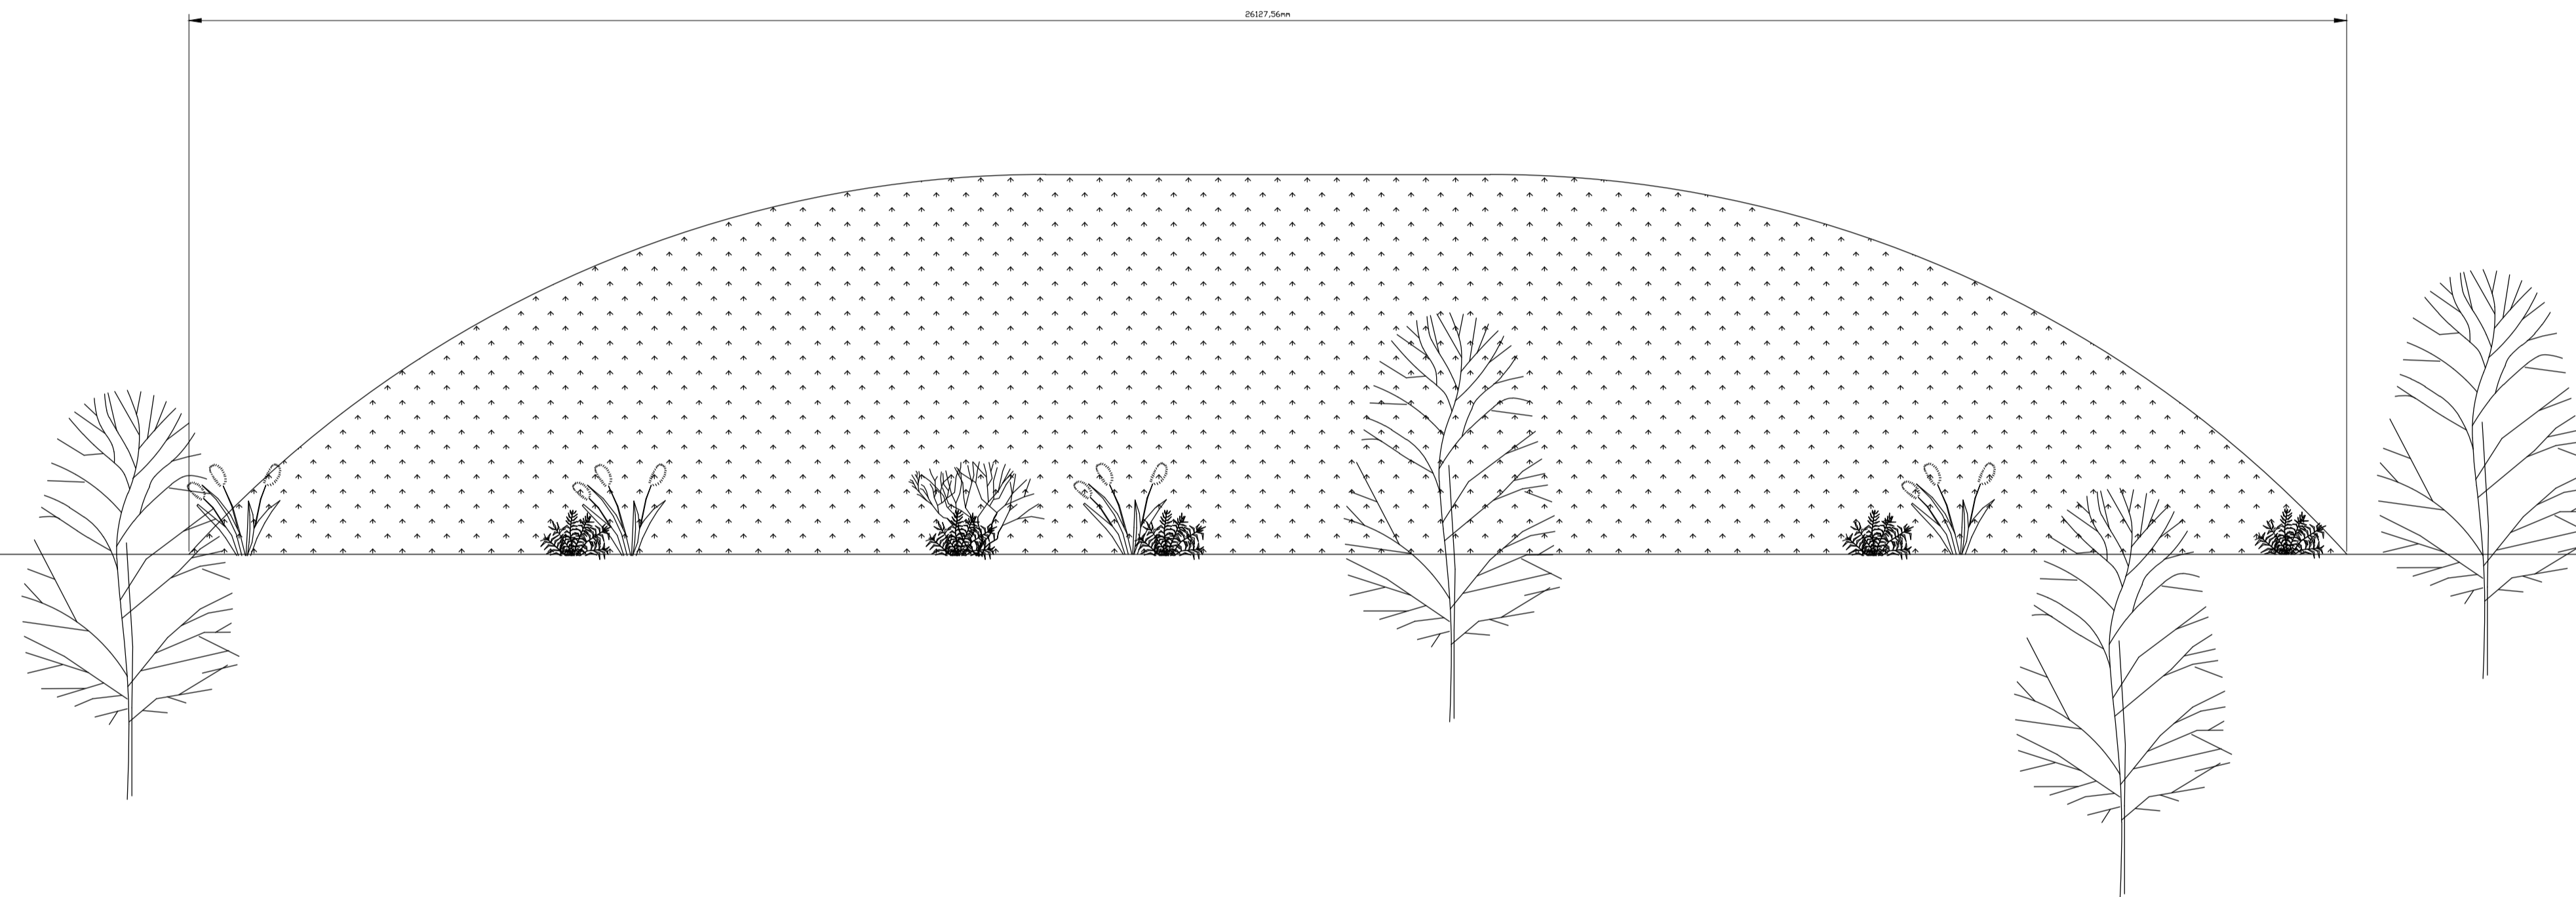

CLIENT/PROJECT

SNRG 307  
Computer Aided Design 1  
House Design Project


PROJECT	DATE
SEMESTER PROJECT	13 / 12 / 2012
DRAWN	APPROVED
Murat Kinaci	

SHEET TITLE

North Elevation

Scale: 1 : 60

SHEET **E-4-13**

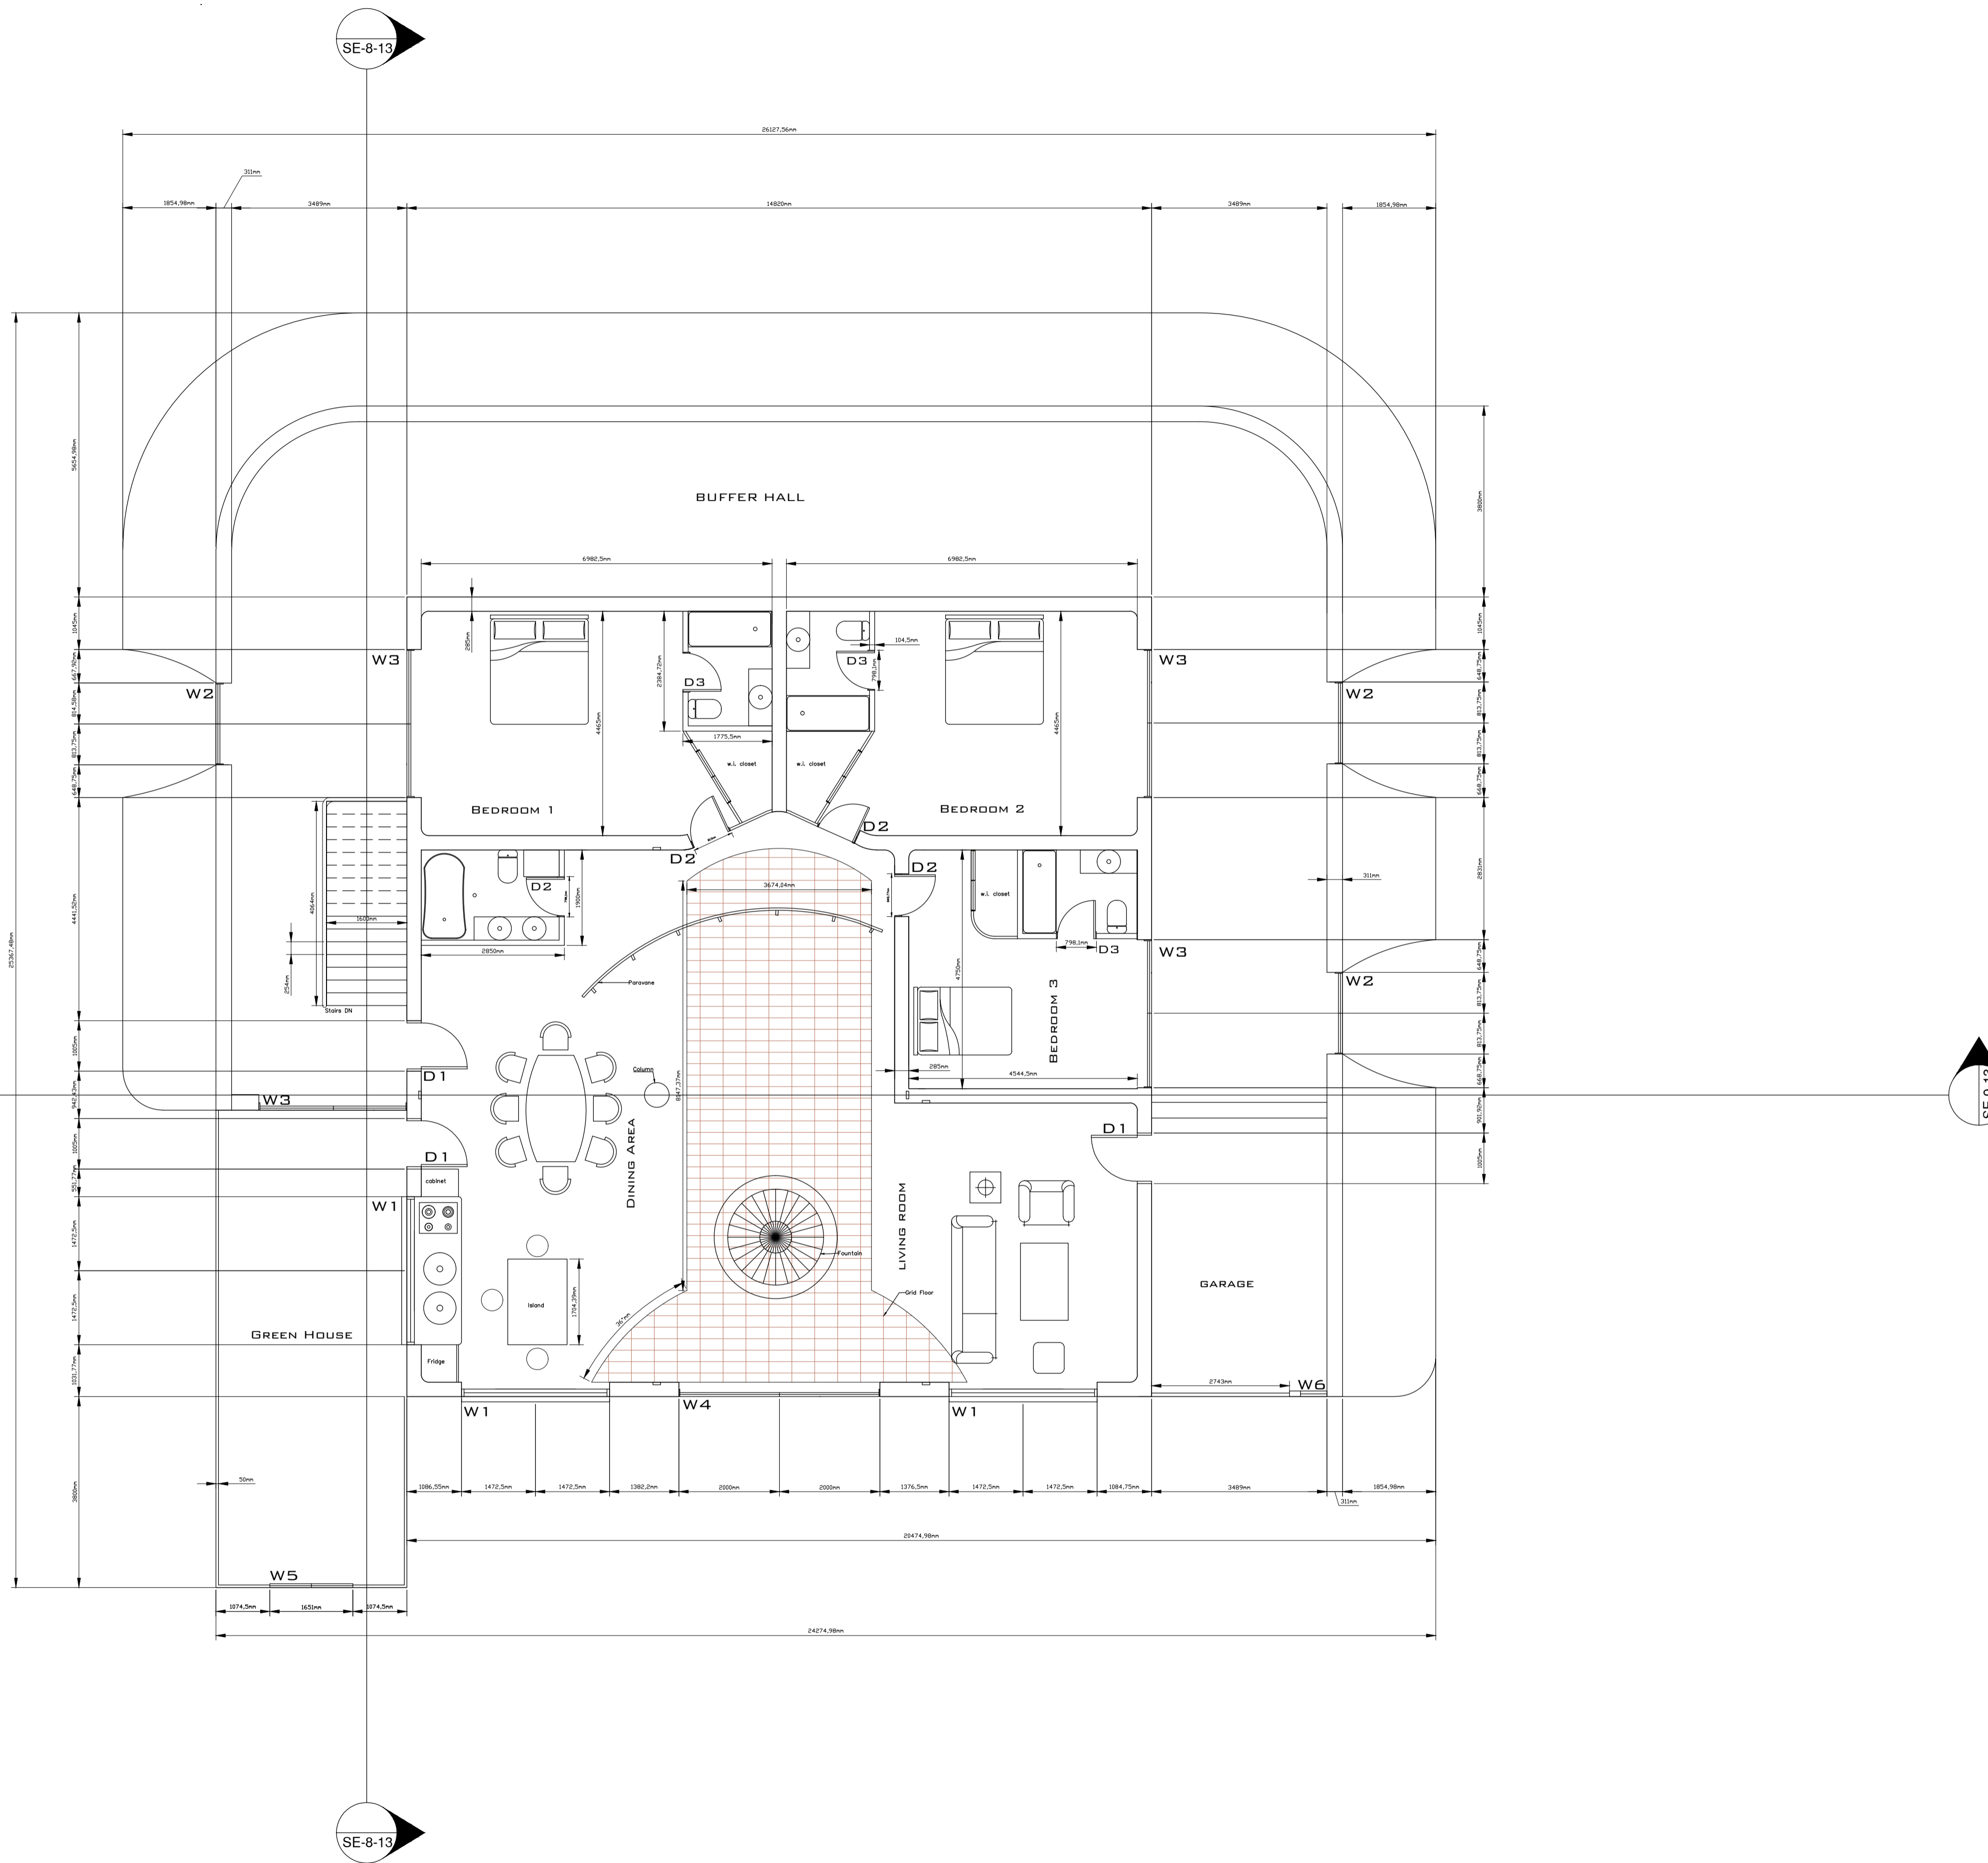

CLIENT/PROJECT  
**SNRG 307**  
**Computer Aided Design 1**  
**House Design Project**


PROJECT SEMESTER PROJECT DATE 13 / 12 / 2012

DRAWN Murat Kinaci

SHEET TITLE  
**ENTRY LEVEL FLOOR PLAN**

Scale: 1 : 75

SHEET **P-5-13**

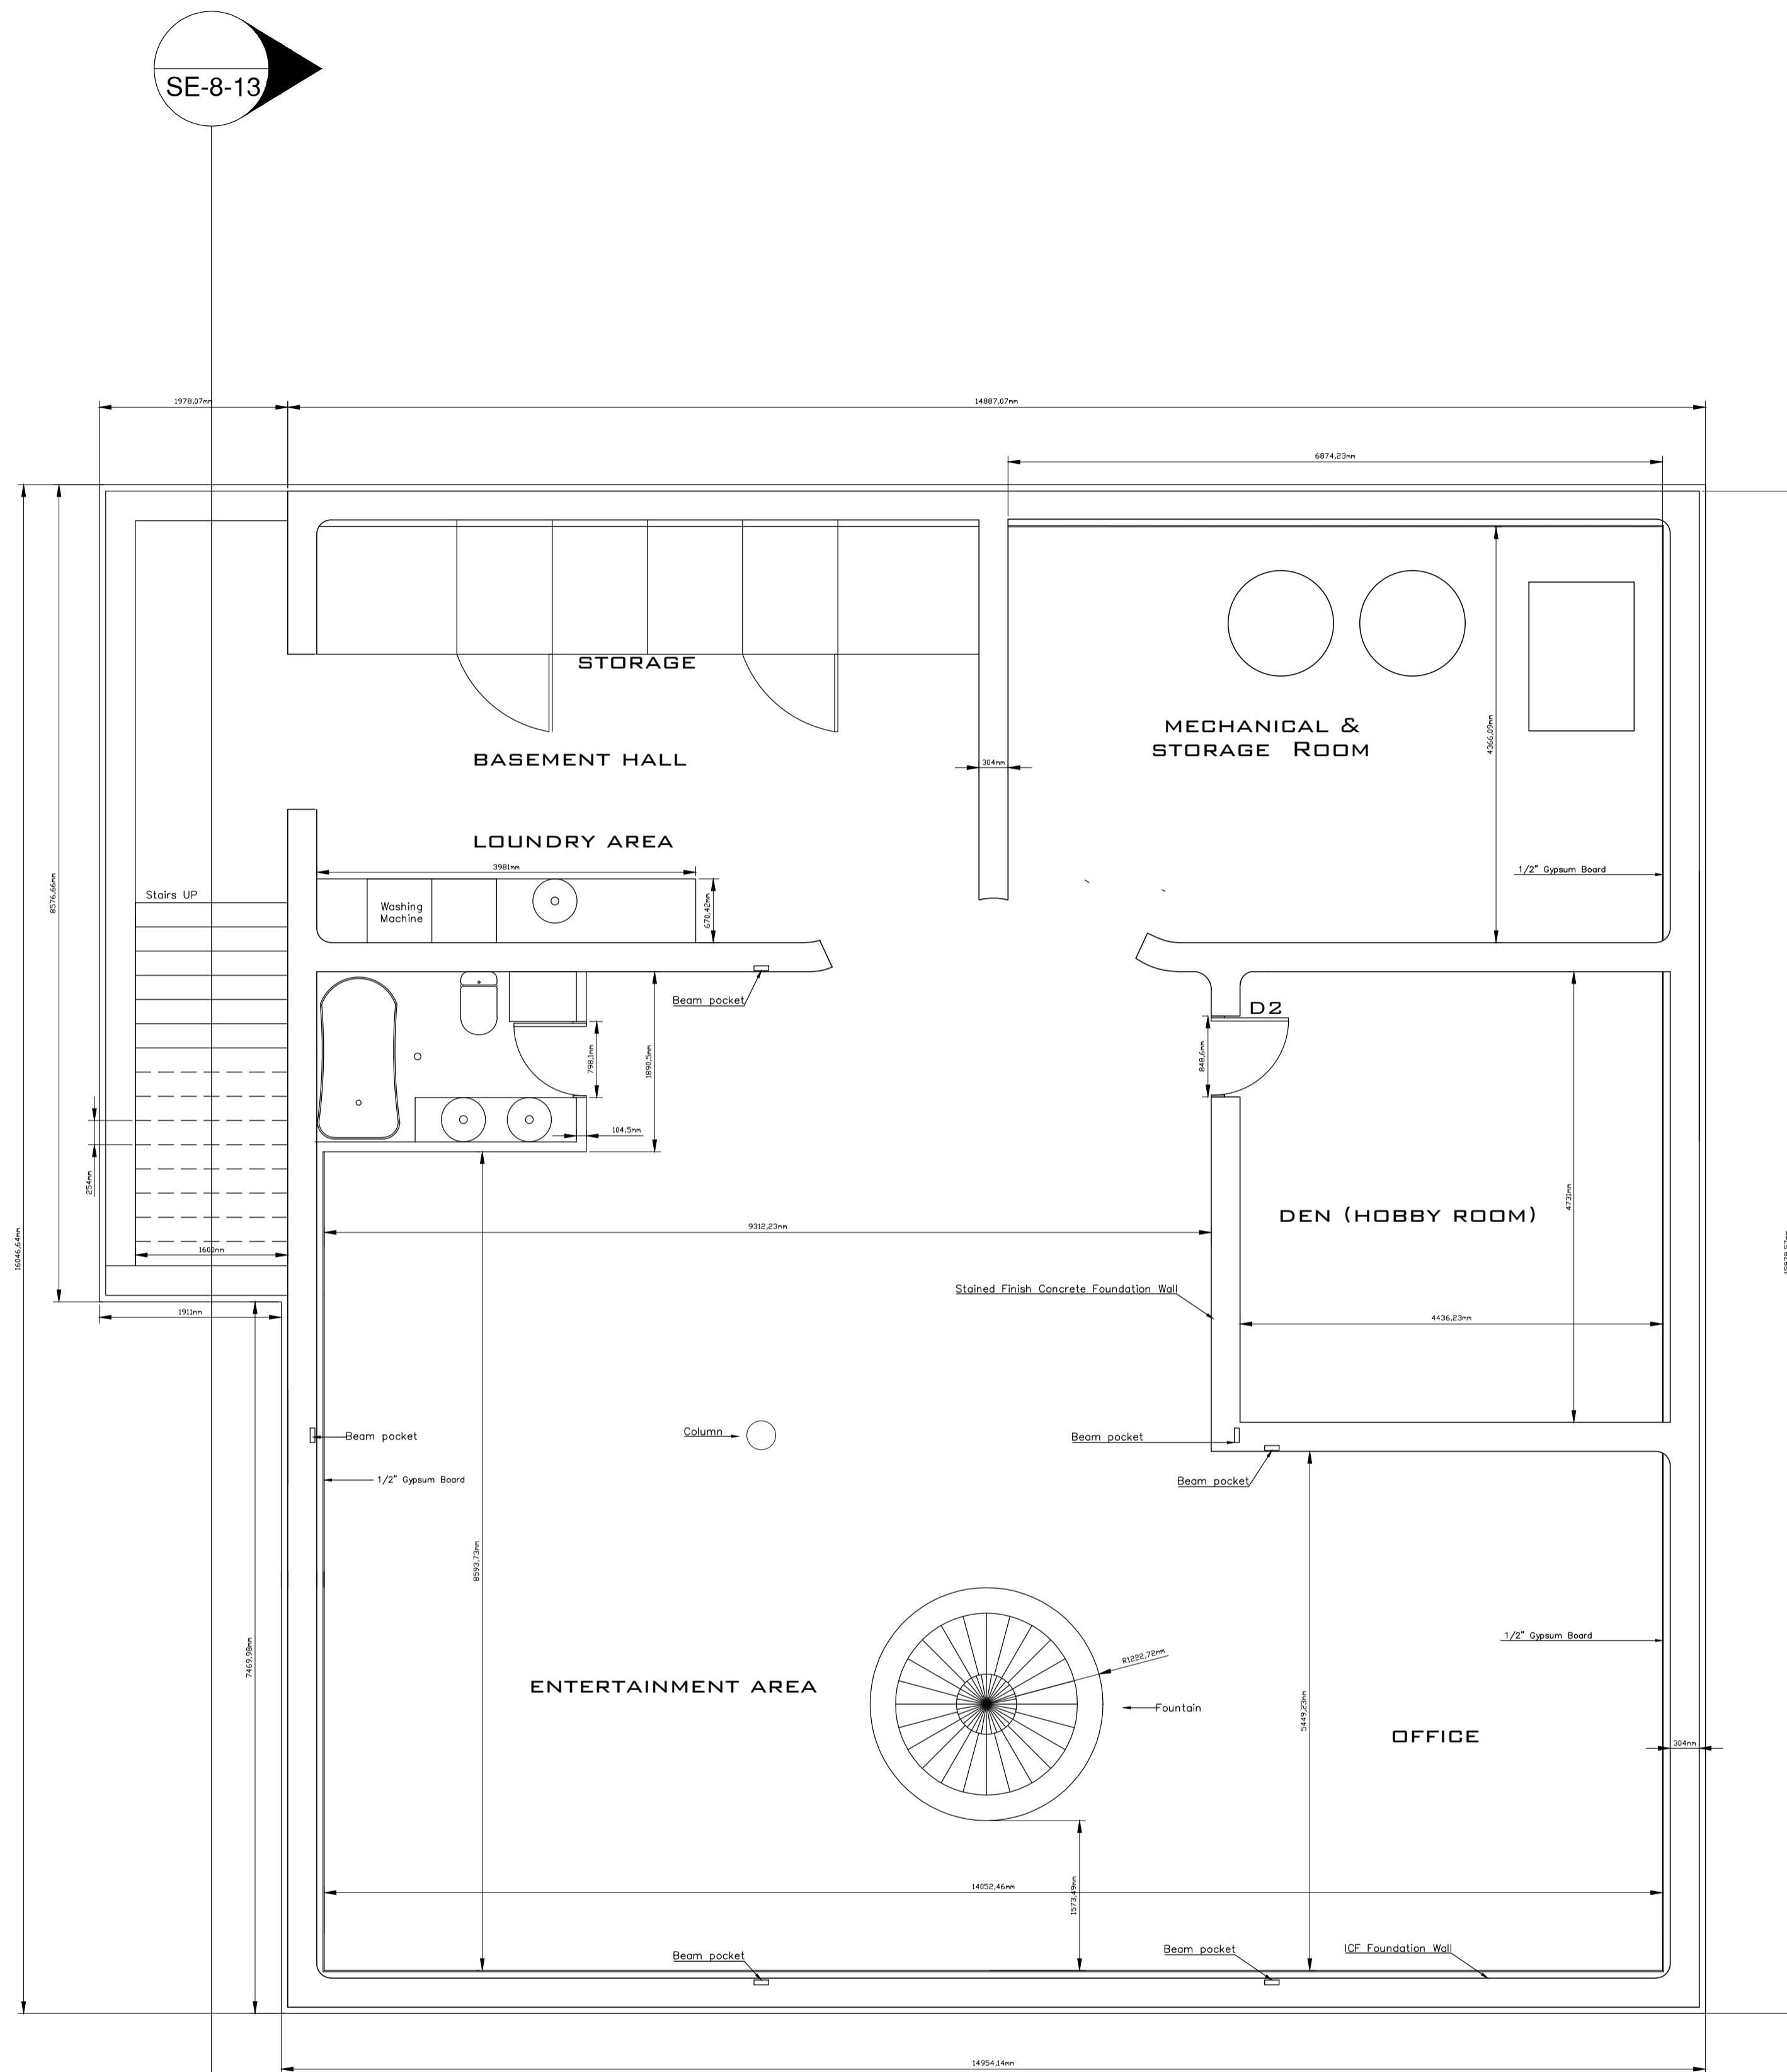

CLIENT/PROJECT

**SNRG 307**  
**Computer Aided Design 1**  
**House Design Project**


PROJECT	DATE
SEMESTER PROJECT	13 / 12 / 2012
DRAWN	APPROVED
Murat Kinaci	

SHEET TITLE

**Basement Plan**

Scale: 1 : 50

SHEET **P-6-13**

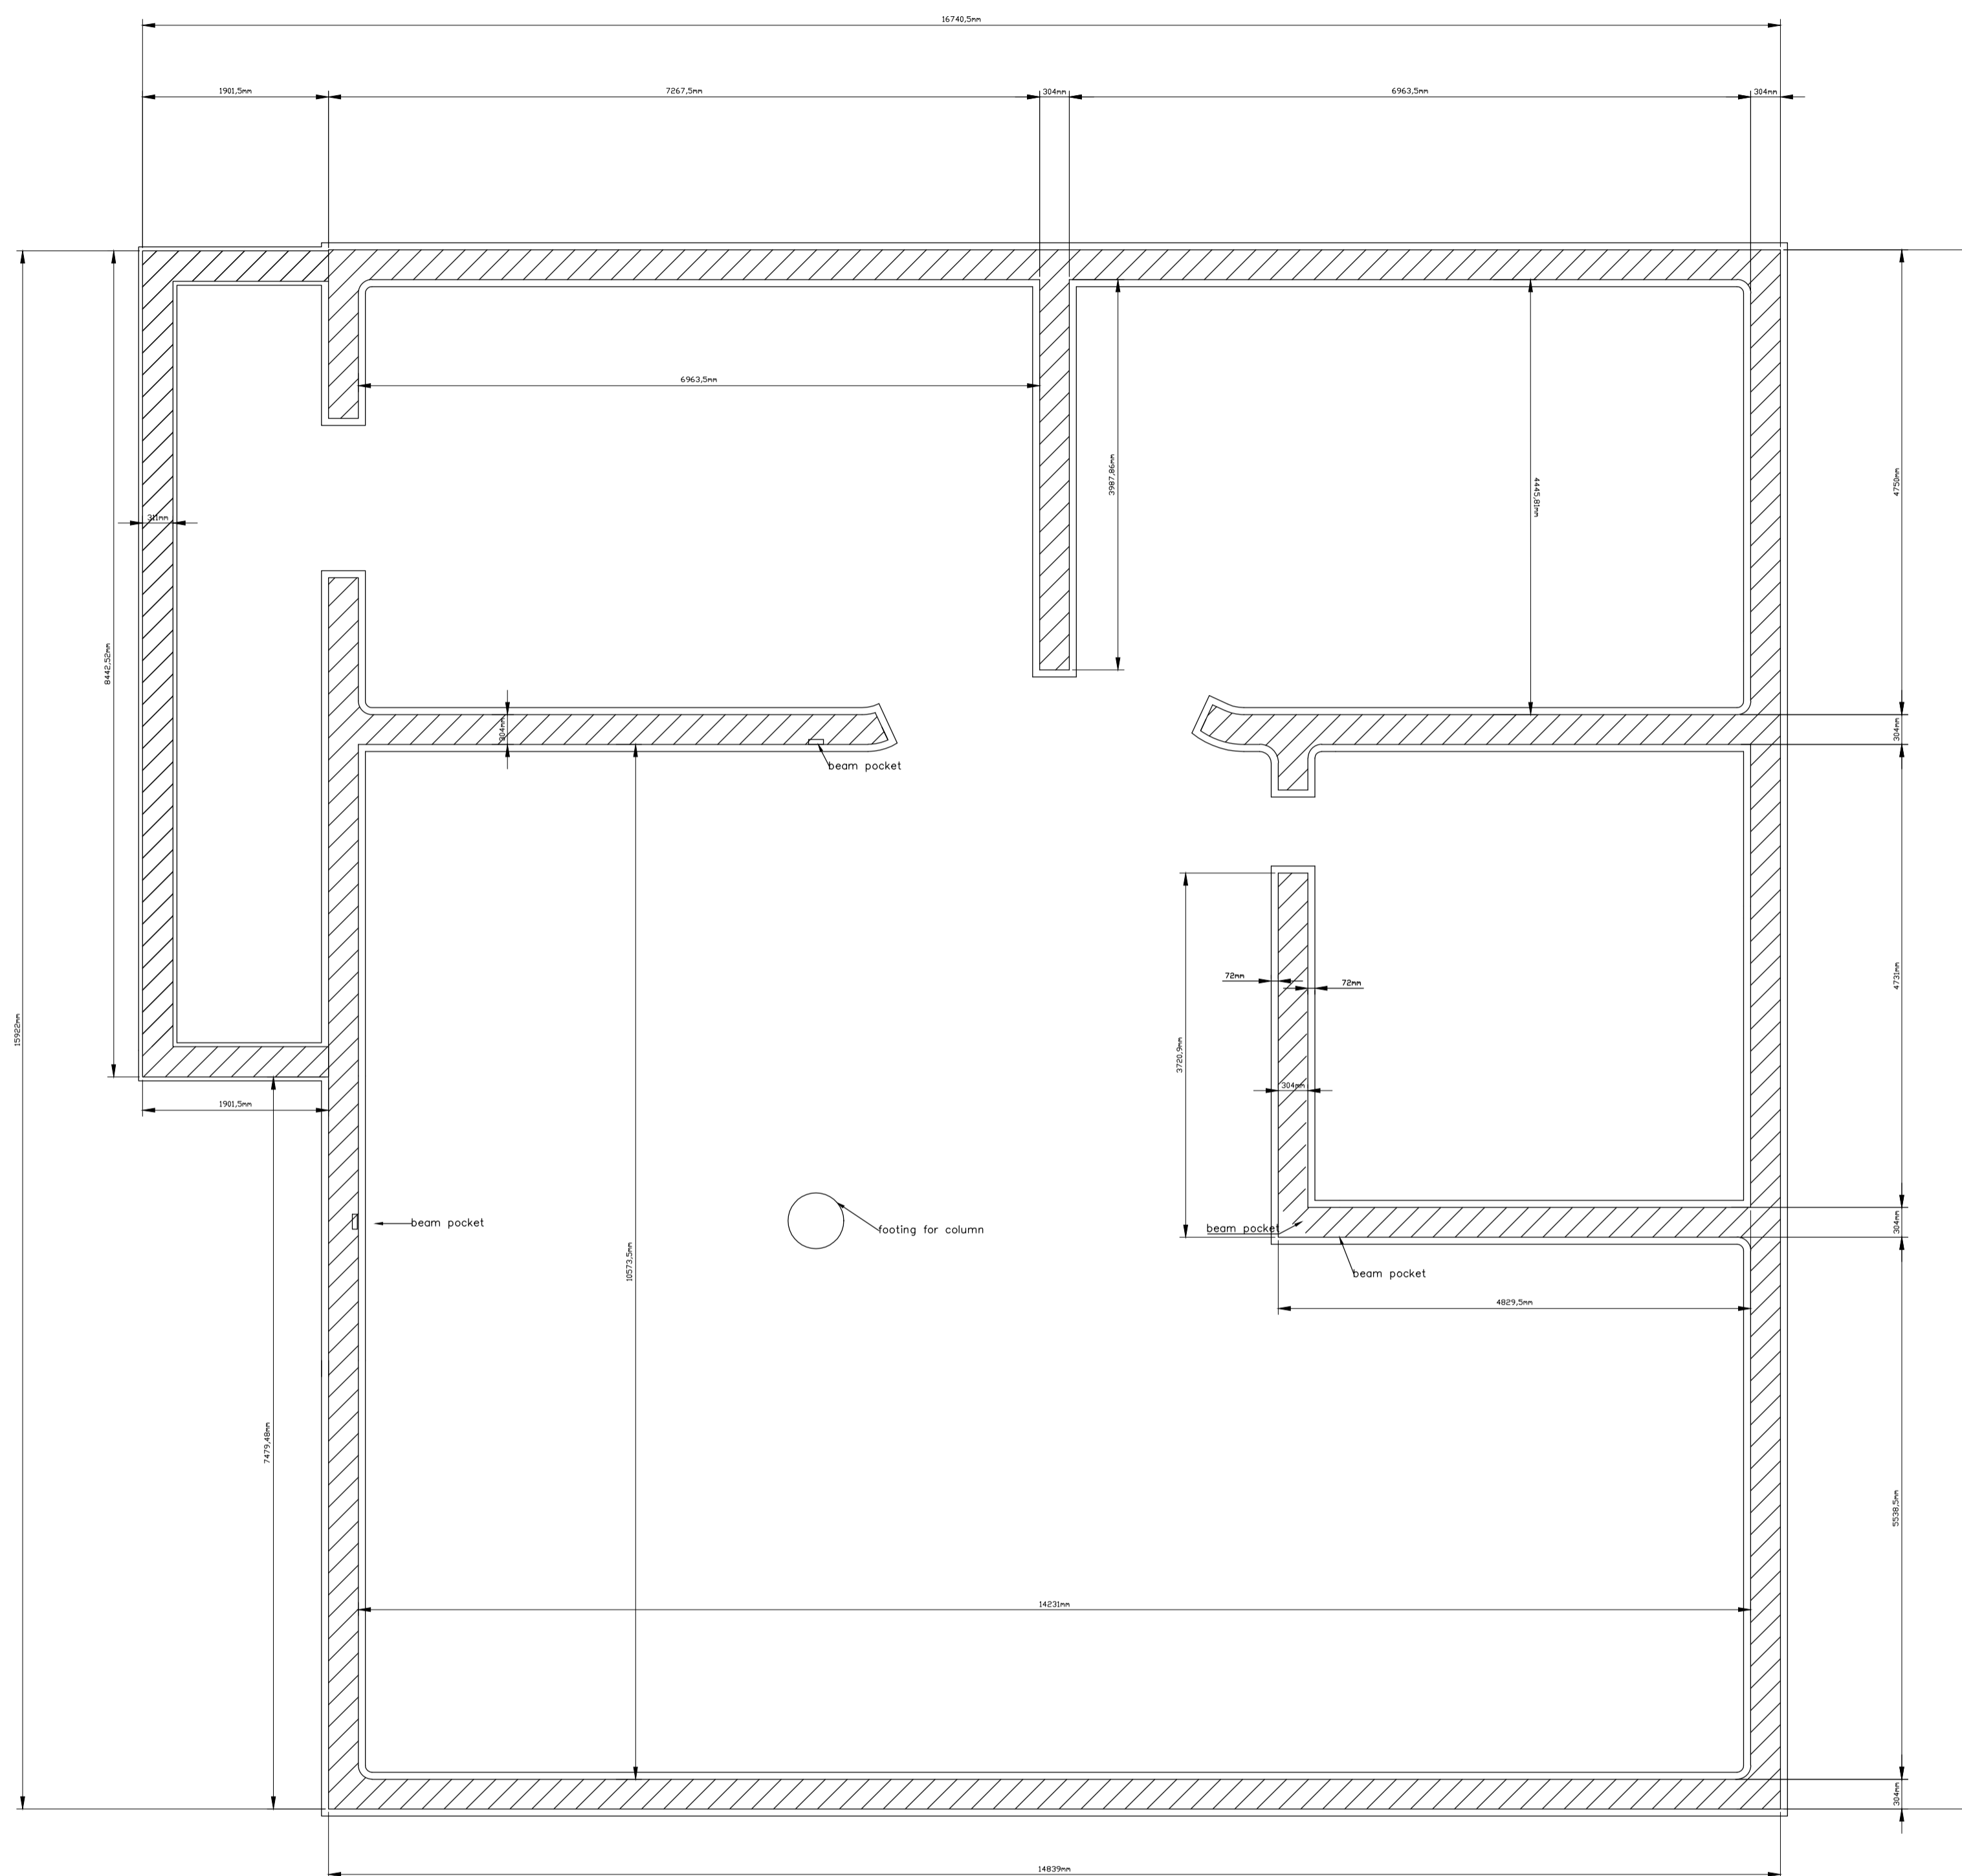


CLIENT/PROJECT  
**SNRG 307**  
**Computer Aided Design 1**  
**House Design Project**

PROJECT SEMESTER PROJECT	DATE 13 / 12 / 2012
DRAWN Murat Kinaci	APPROVED

SHEET TITLE  
**Foundation Plan**

Scale: 1 : 50

SHEET  
**P-7-13**

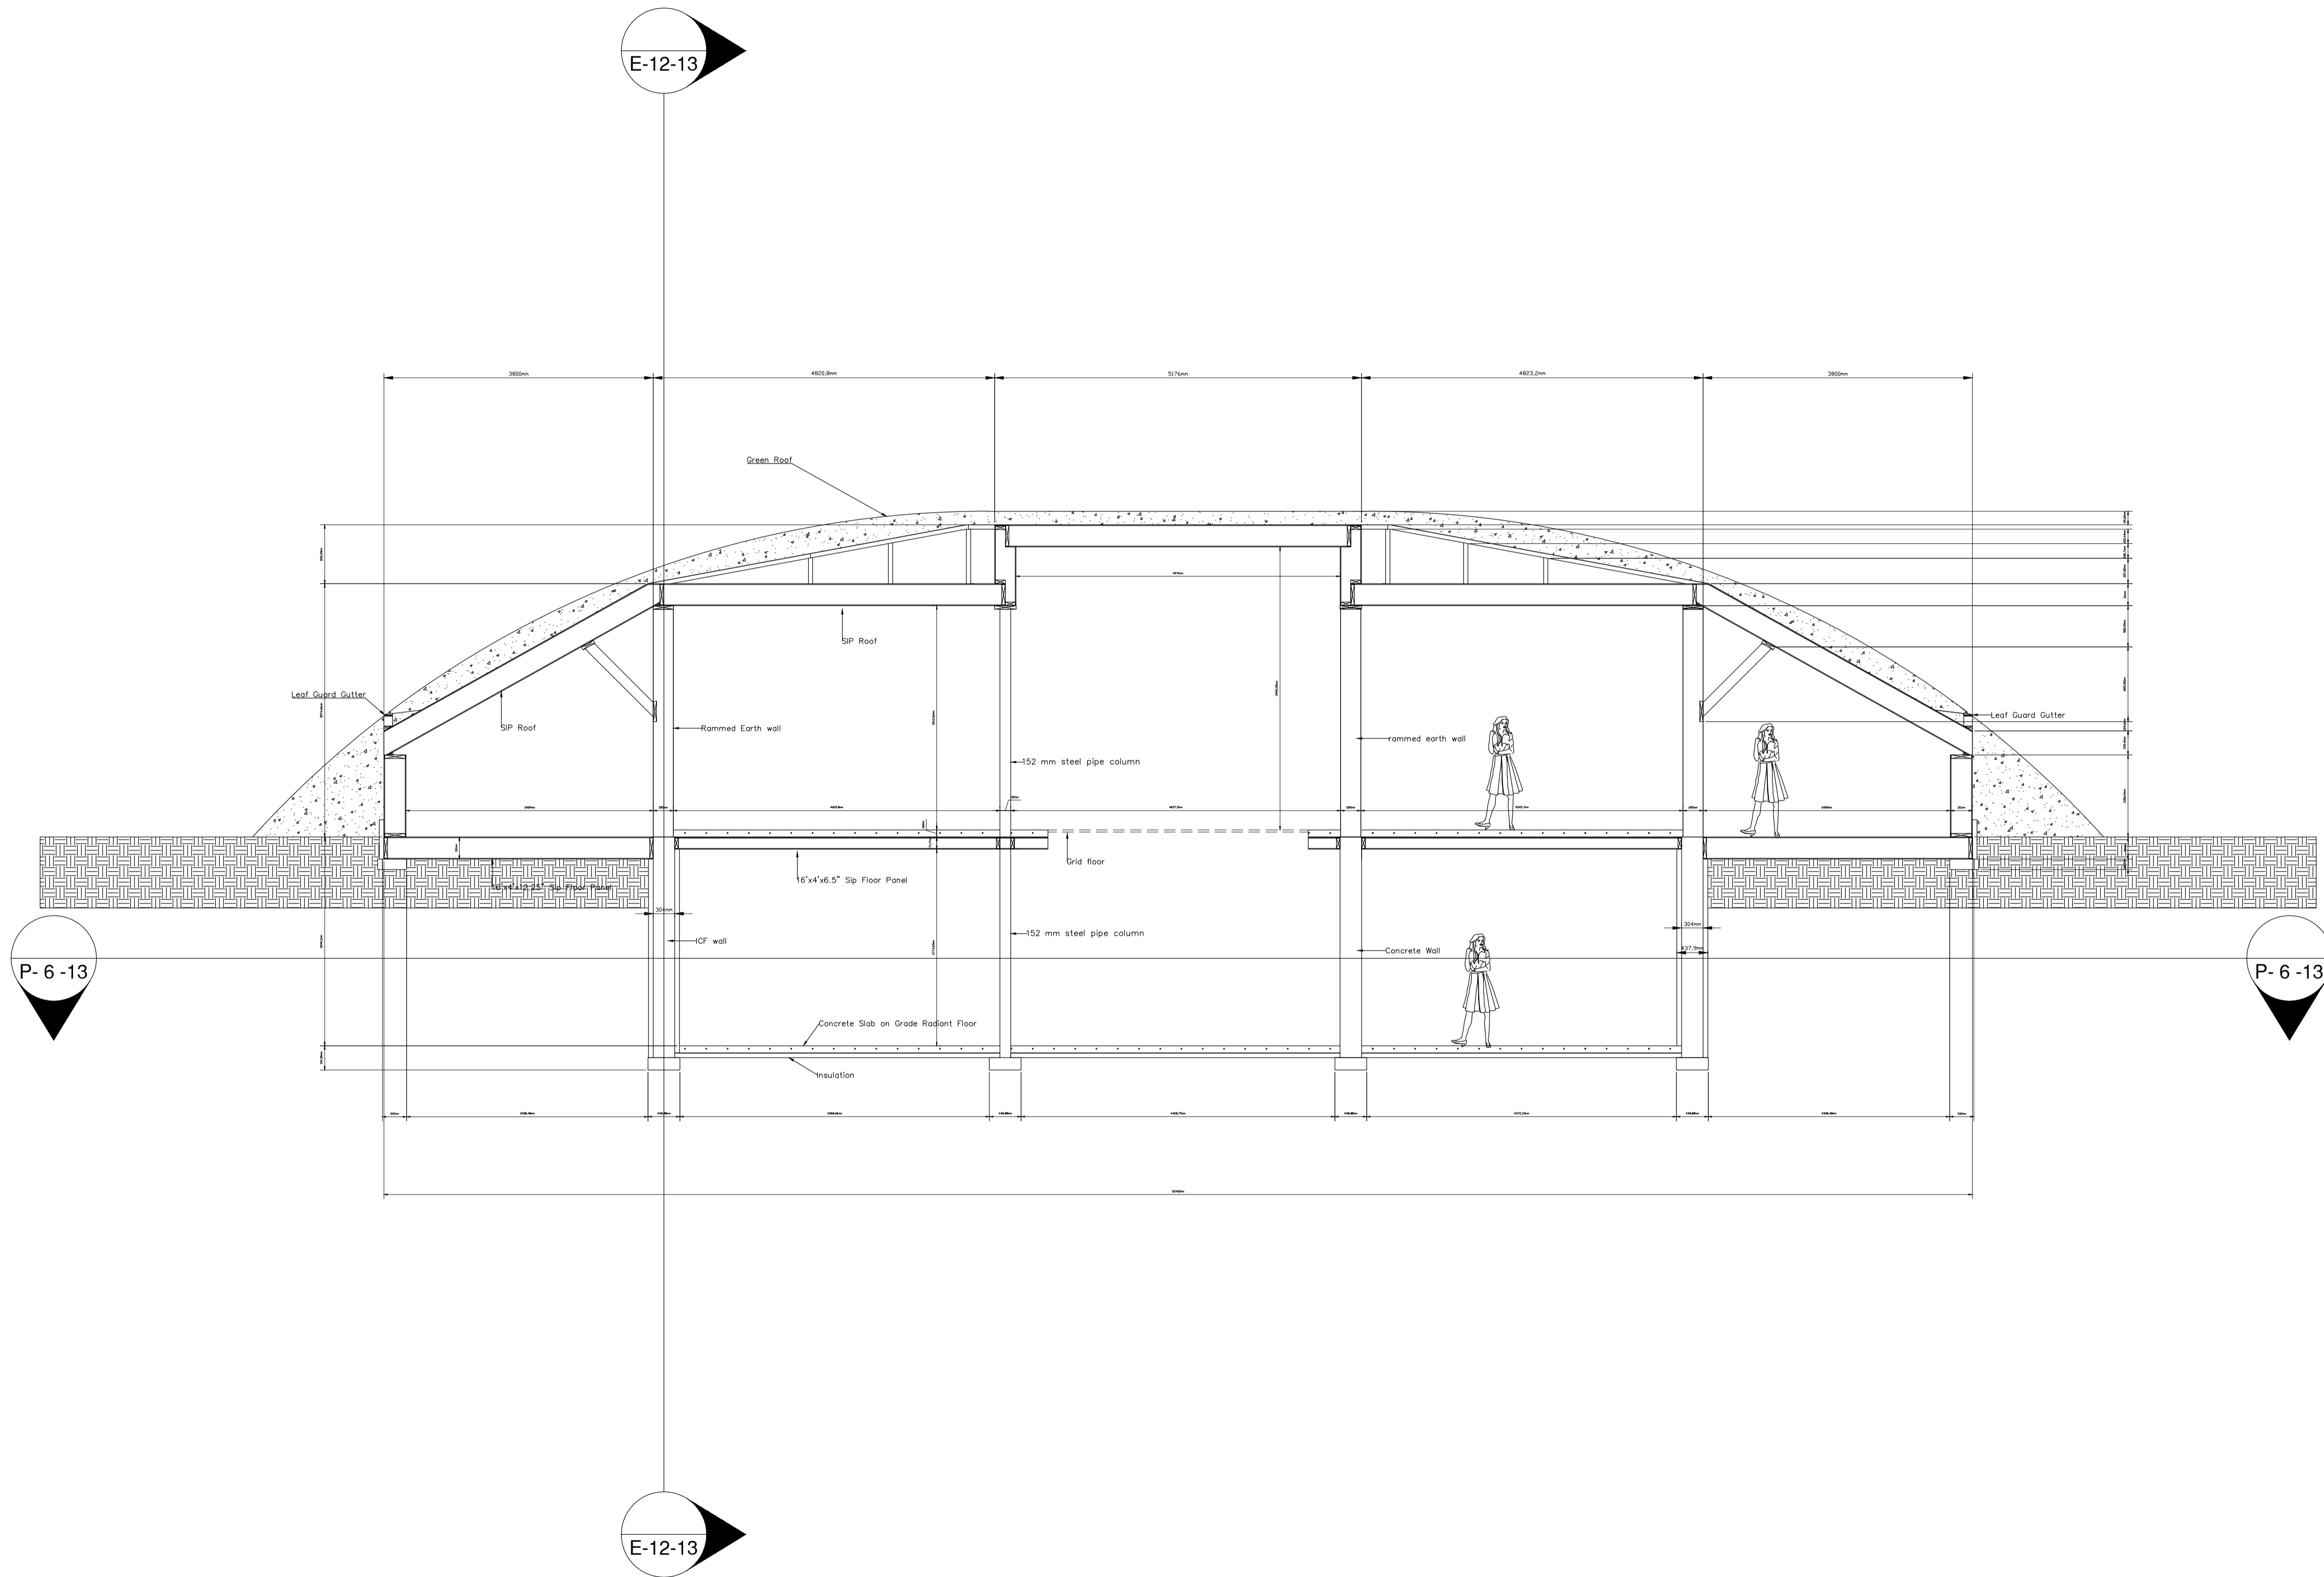

CLIENT/PROJECT


**SNRG 307**  
**Computer Aided Design 1**  
**House Design Project**

PROJECT	DATE
SEMESTER PROJECT	13 / 12 / 2012
DRAWN	APPROVED
Murat Kinaci	

SHEET TITLE  
**Section View E/W**

Scale: 1 : 50

SHEET  
**SE-8-13**

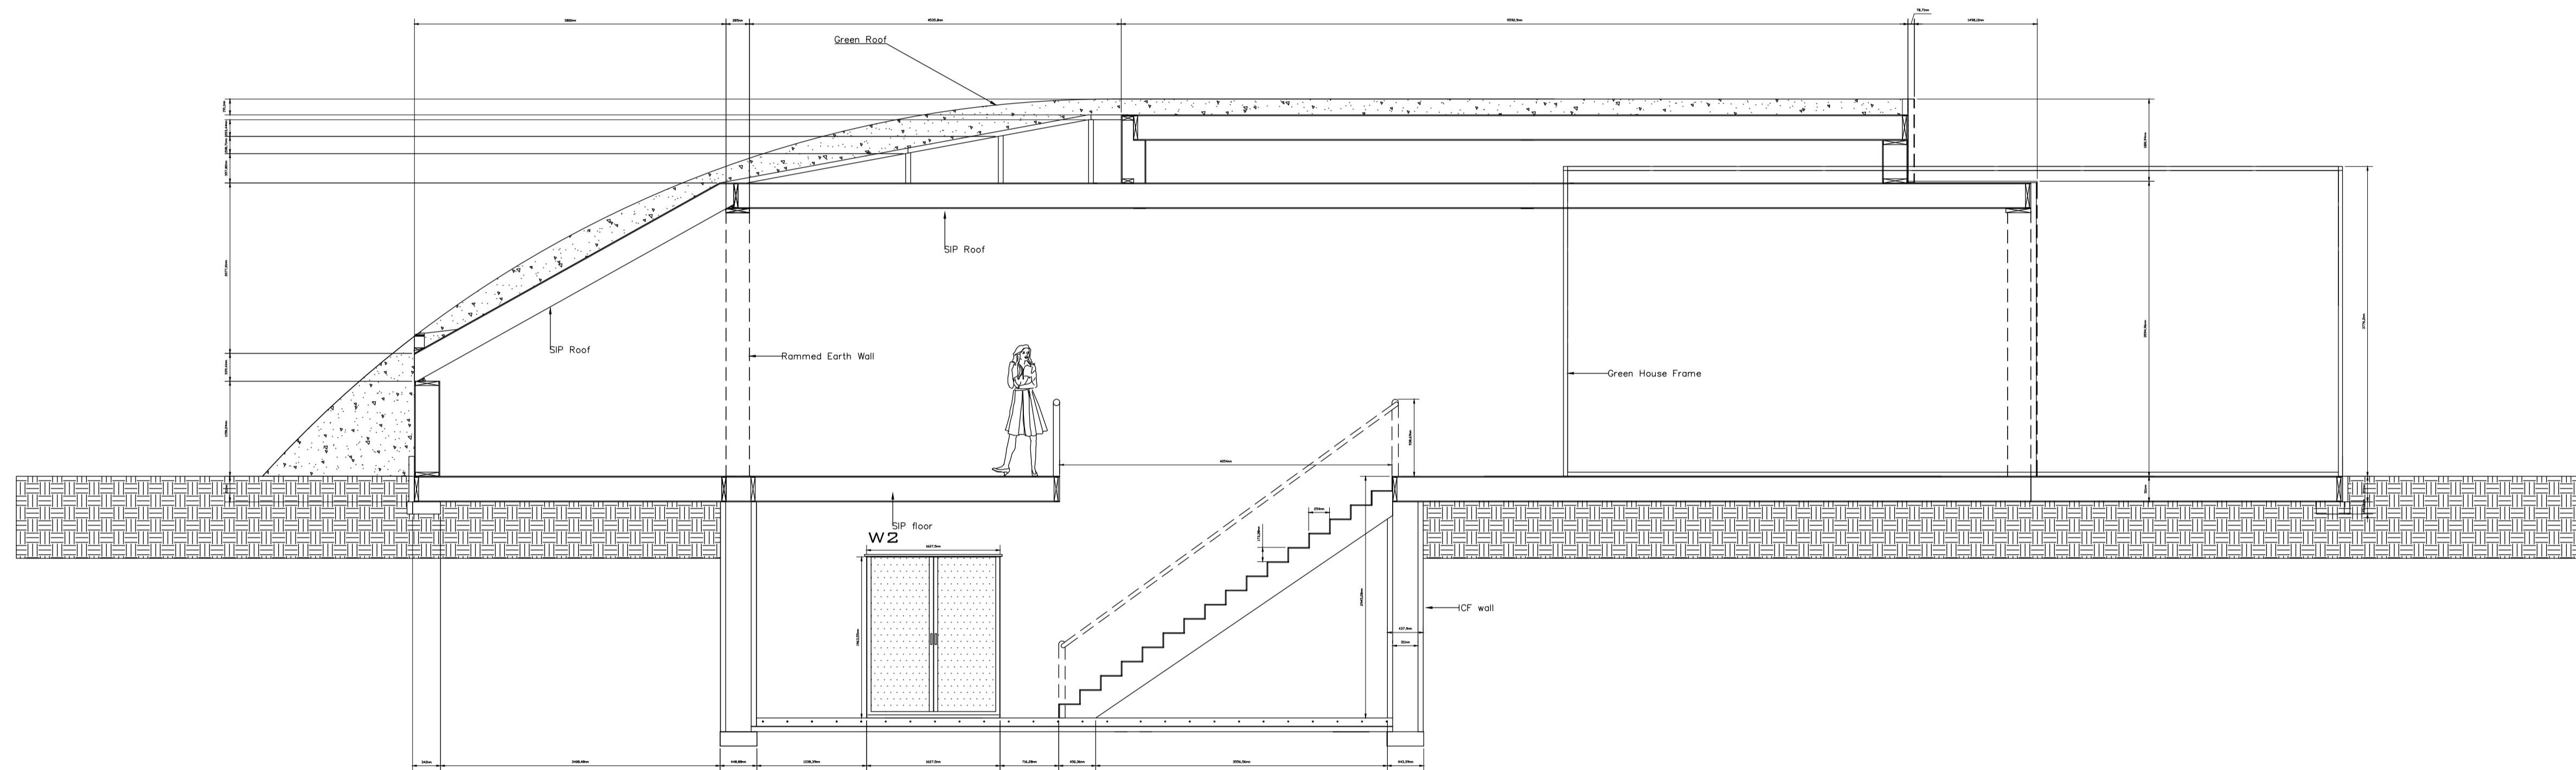

CLIENT/PROJECT

**SNRG 307**  
**Computer Aided Design 1**  
**House Design Project**

PROJECT	DATE
SEMESTER PROJECT	13 / 12 / 2012


DRAWN	APPROVED
Murat Kinaci	

SHEET TITLE

**Section View N/S**

**Scale: 1 : 50**

SHEET **SE-9-13**

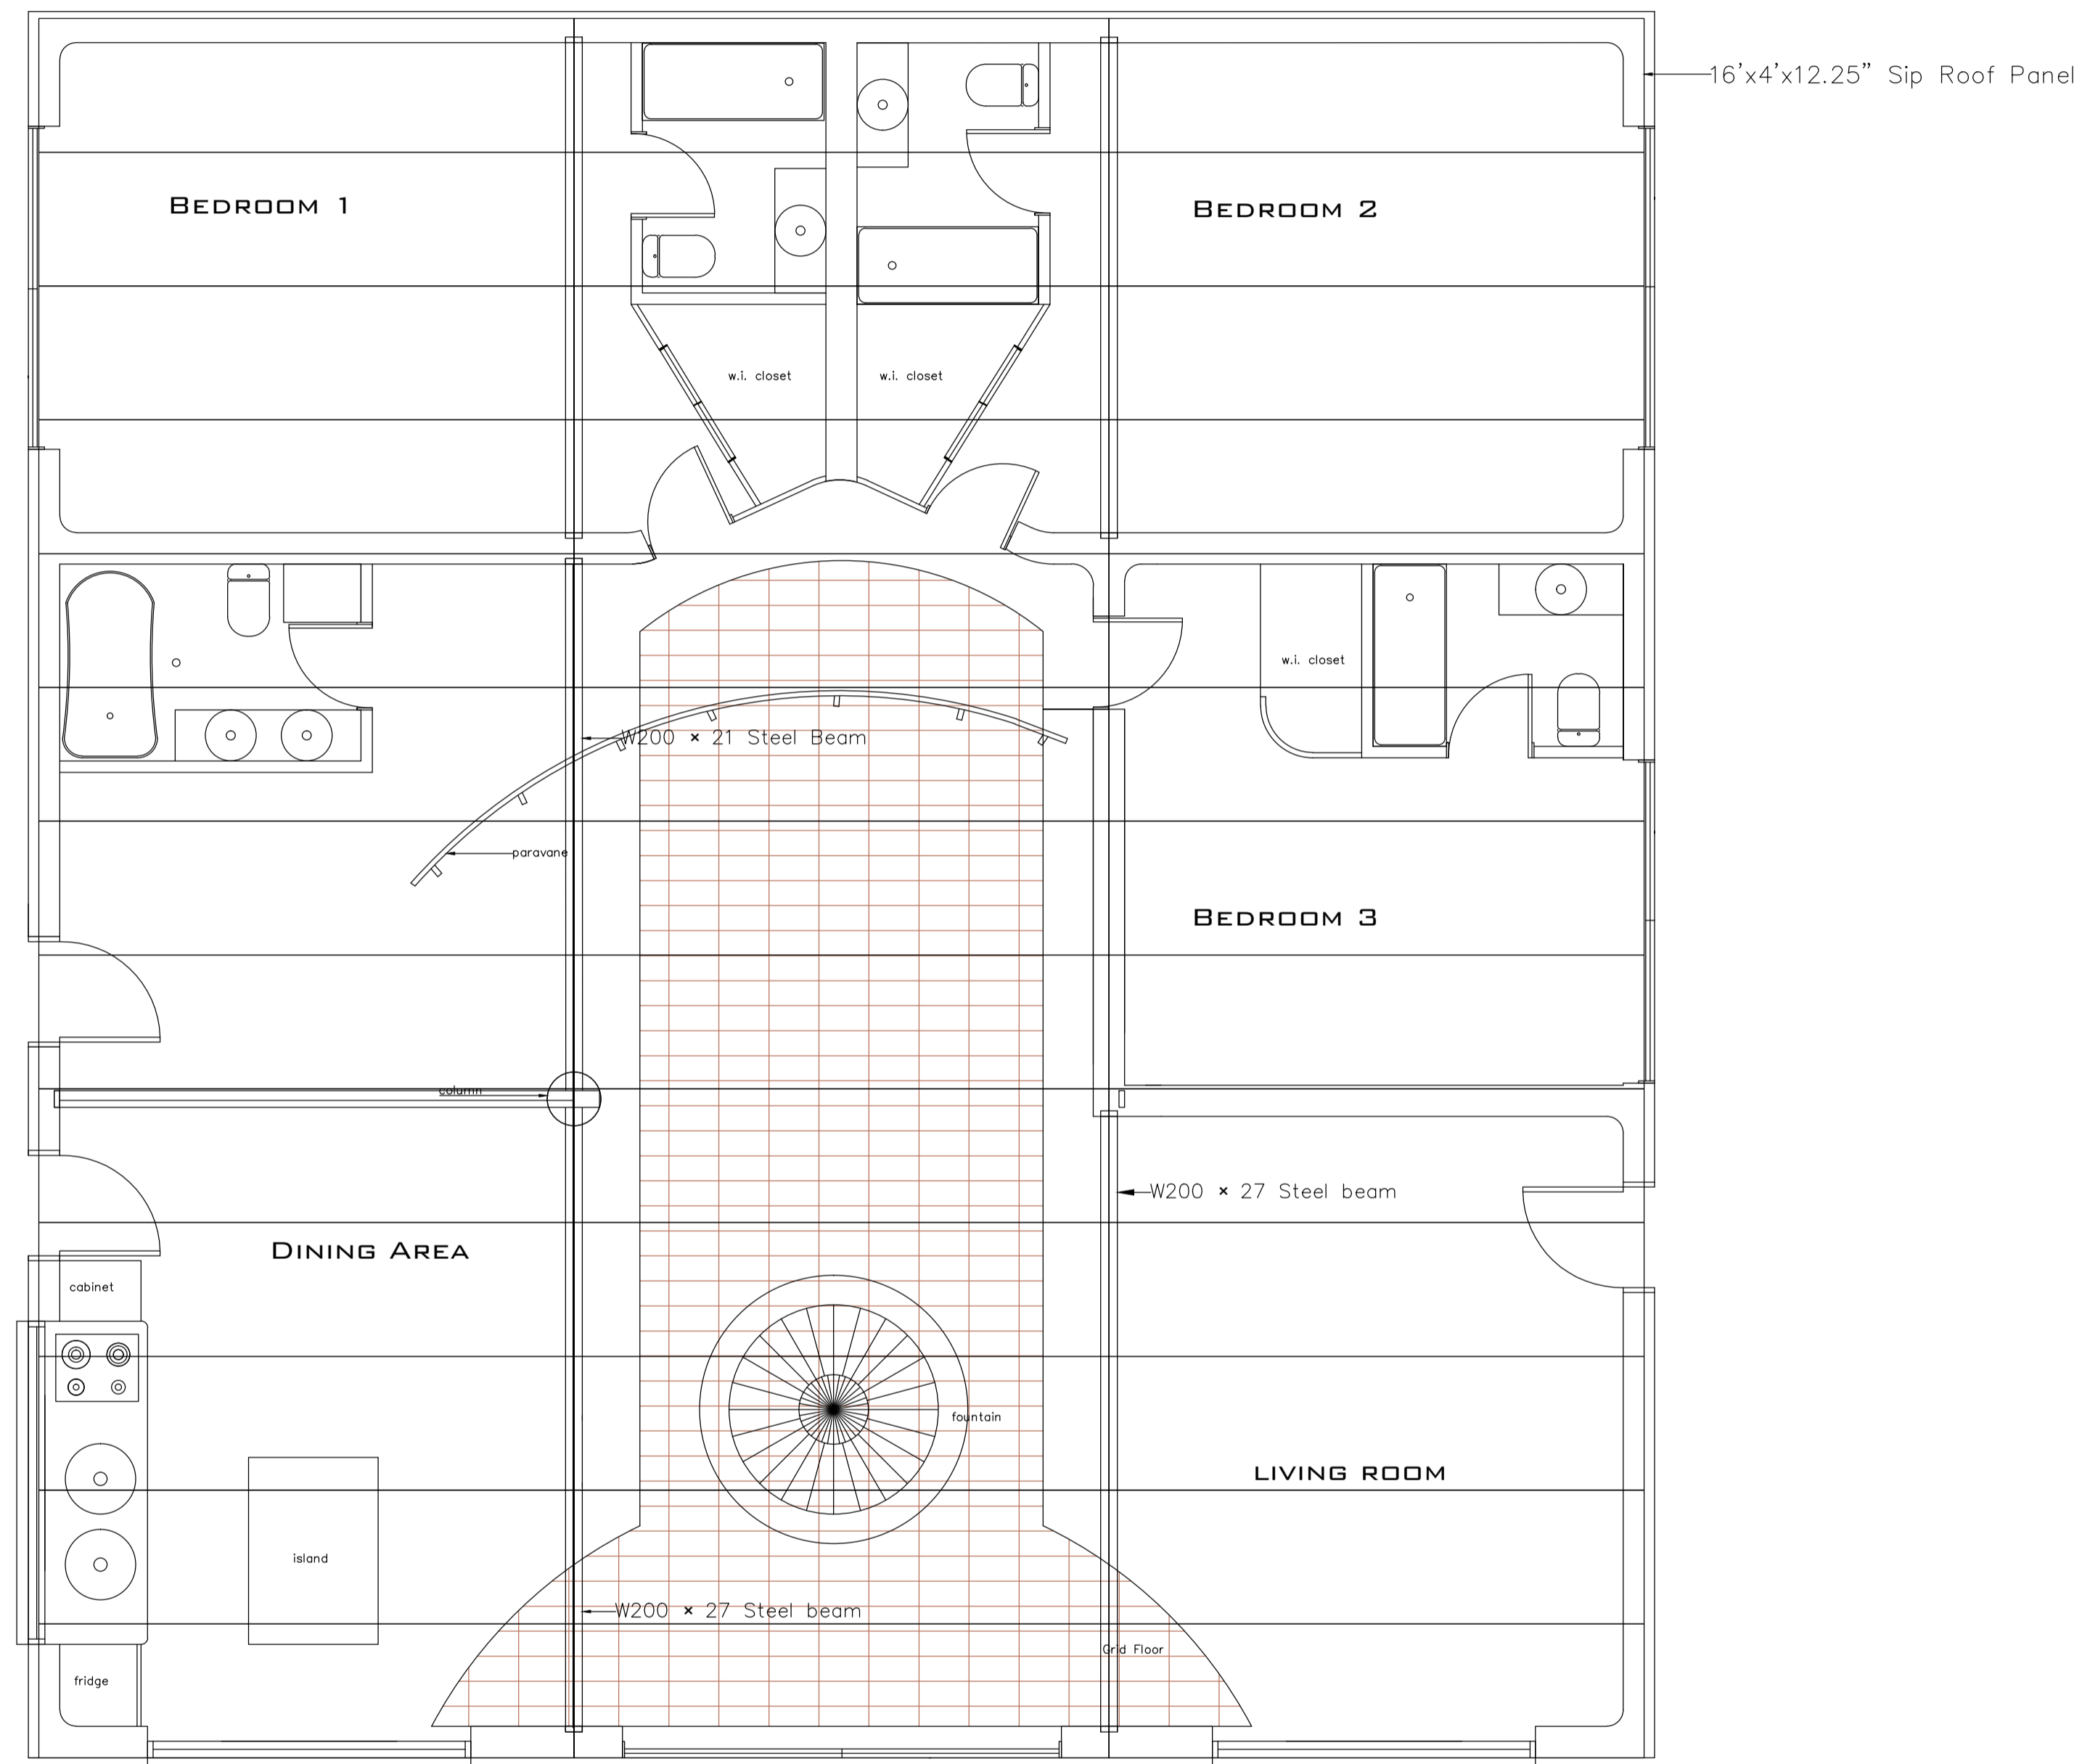

Roof



CLIENT/PROJECT

**SNRG 307**  
**Computer Aided Design 1**  
**House Design Project**

PROJECT	DATE
SEMESTER PROJECT	13 / 12 / 2012


DRAWN	APPROVED
Murat Kinaci	

SHEET TITLE

**Roof Framing**

Scale: 1 : 50

SHEET **F-10-13**

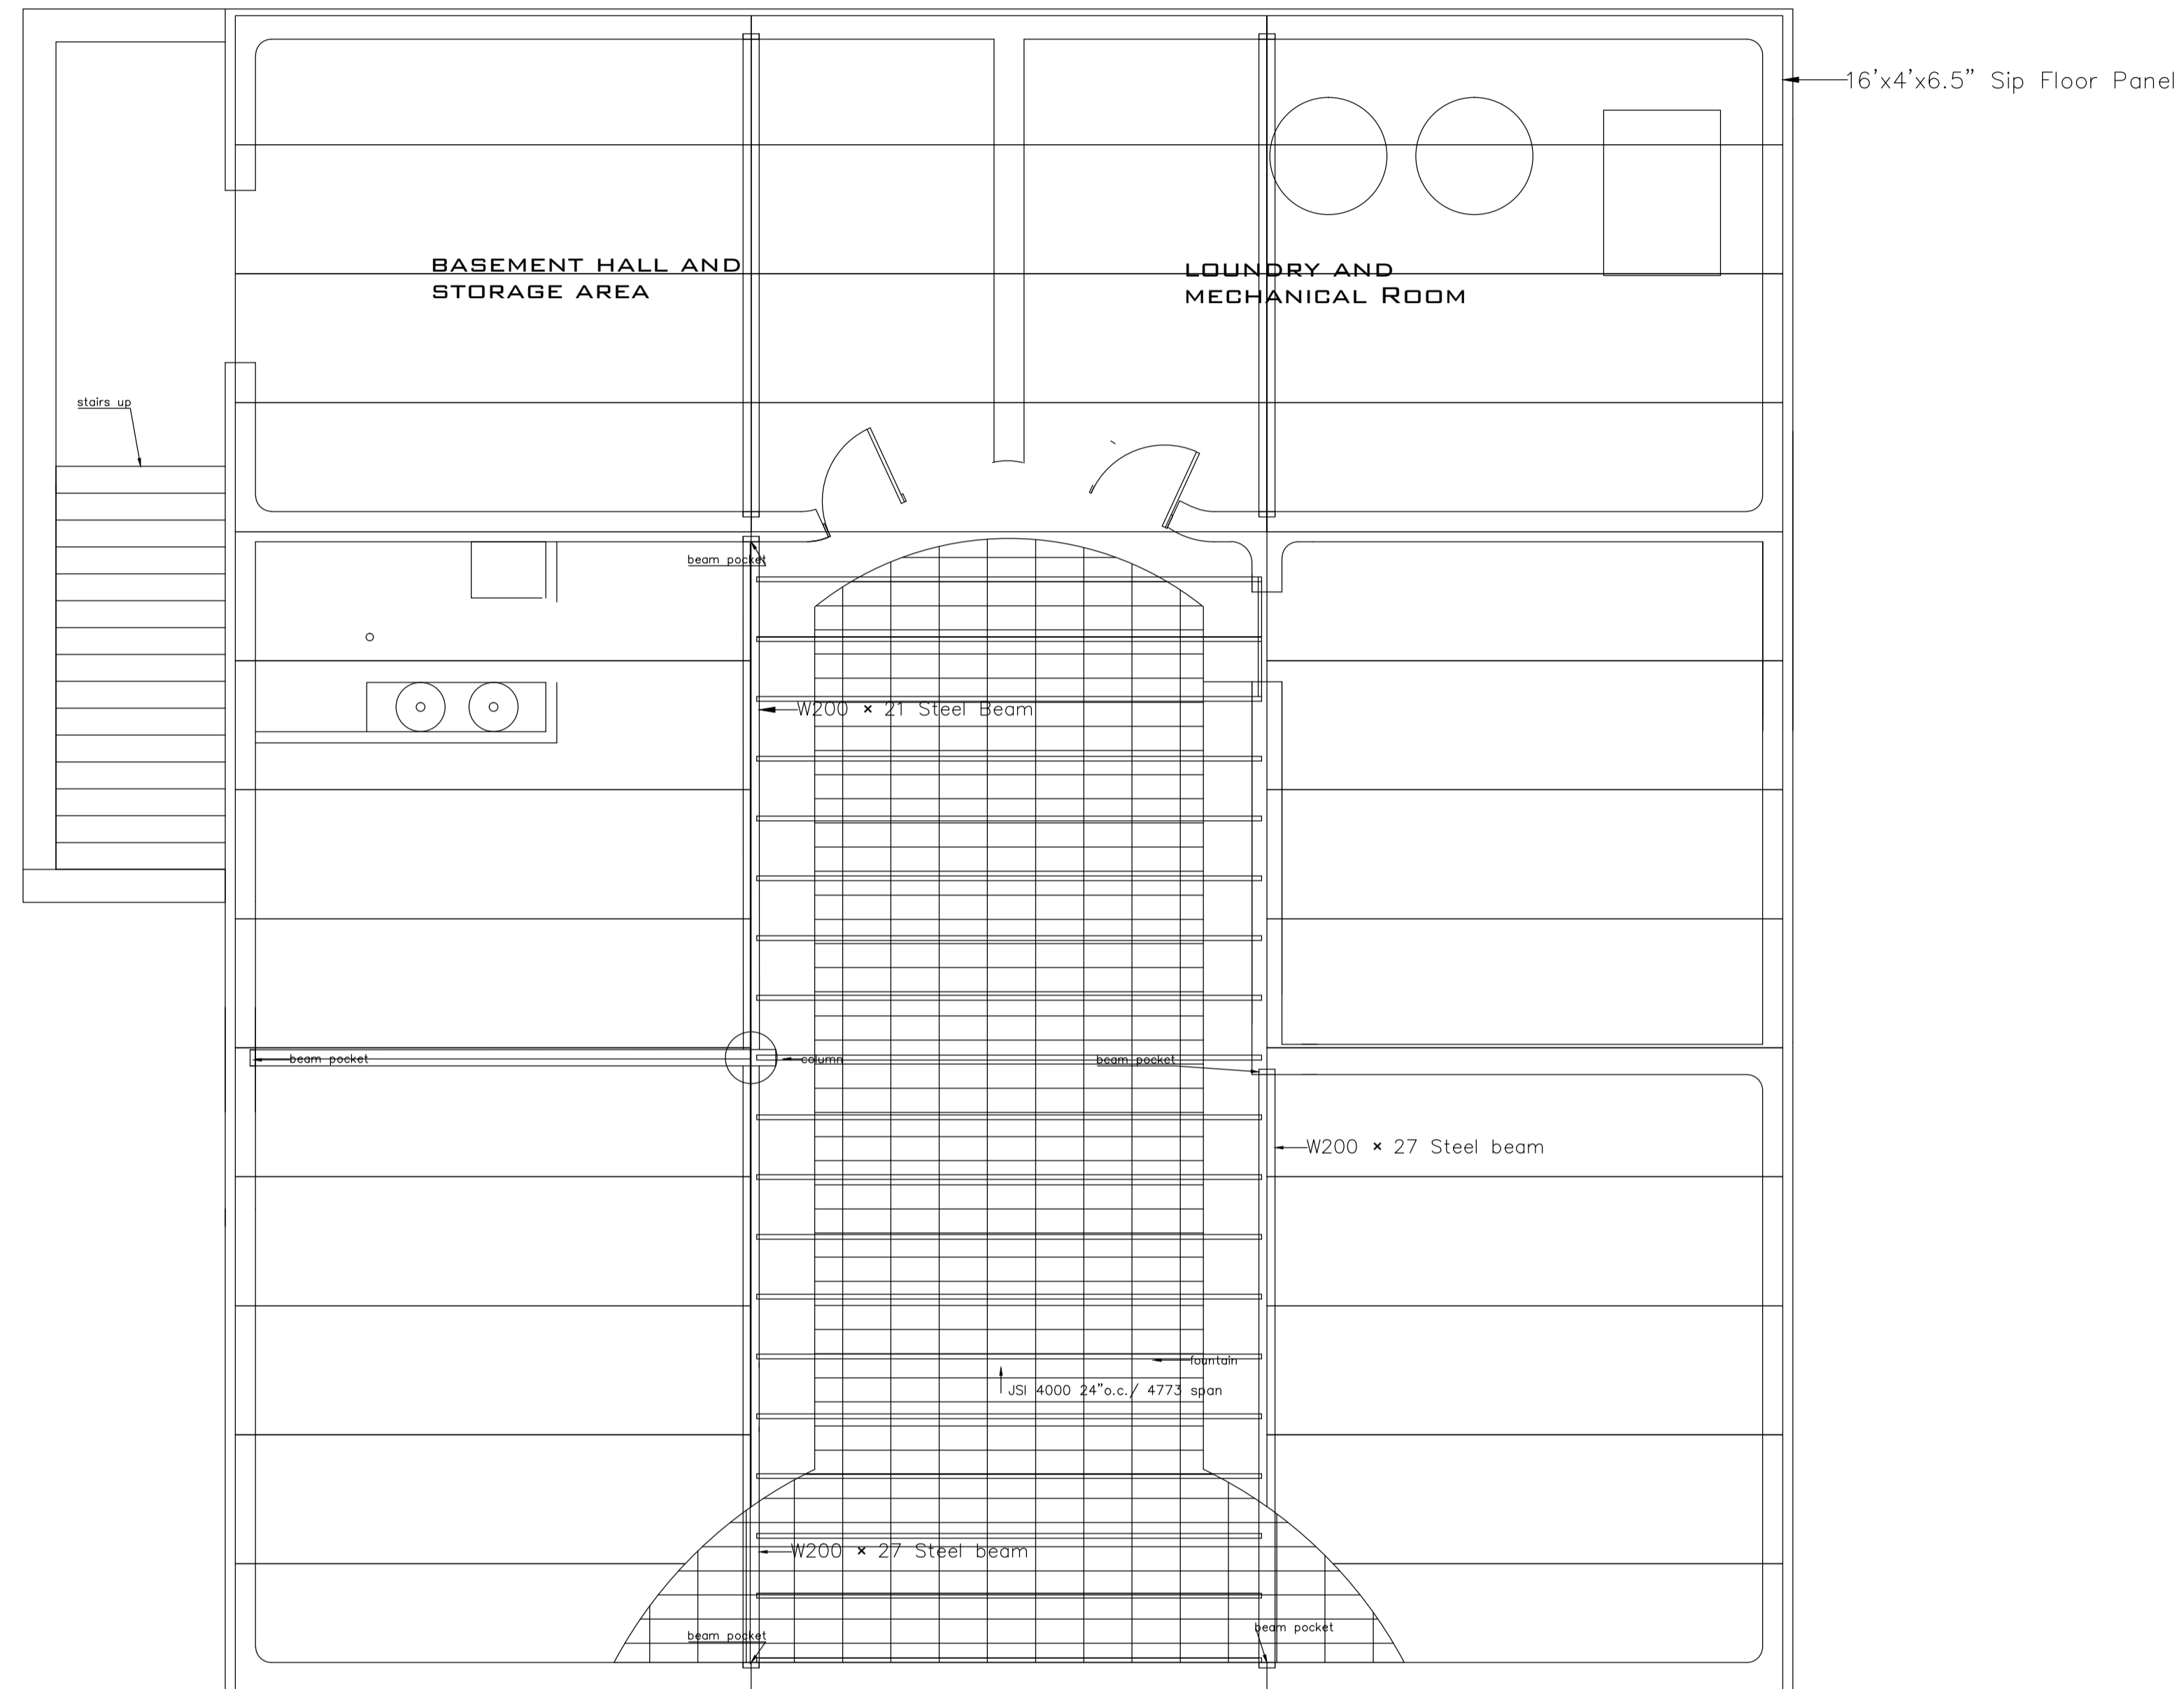

First Floor



CLIENT/PROJECT

**SNRG 307**  
**Computer Aided Design 1**  
**House Design Project**

PROJECT	DATE
SEMESTER PROJECT	13 / 12 / 2012


DRAWN	APPROVED
Murat Kinaci	

SHEET TITLE

**First Floor Ceiling Framing**

Scale: 1 : 50

SHEET **F-11-13**

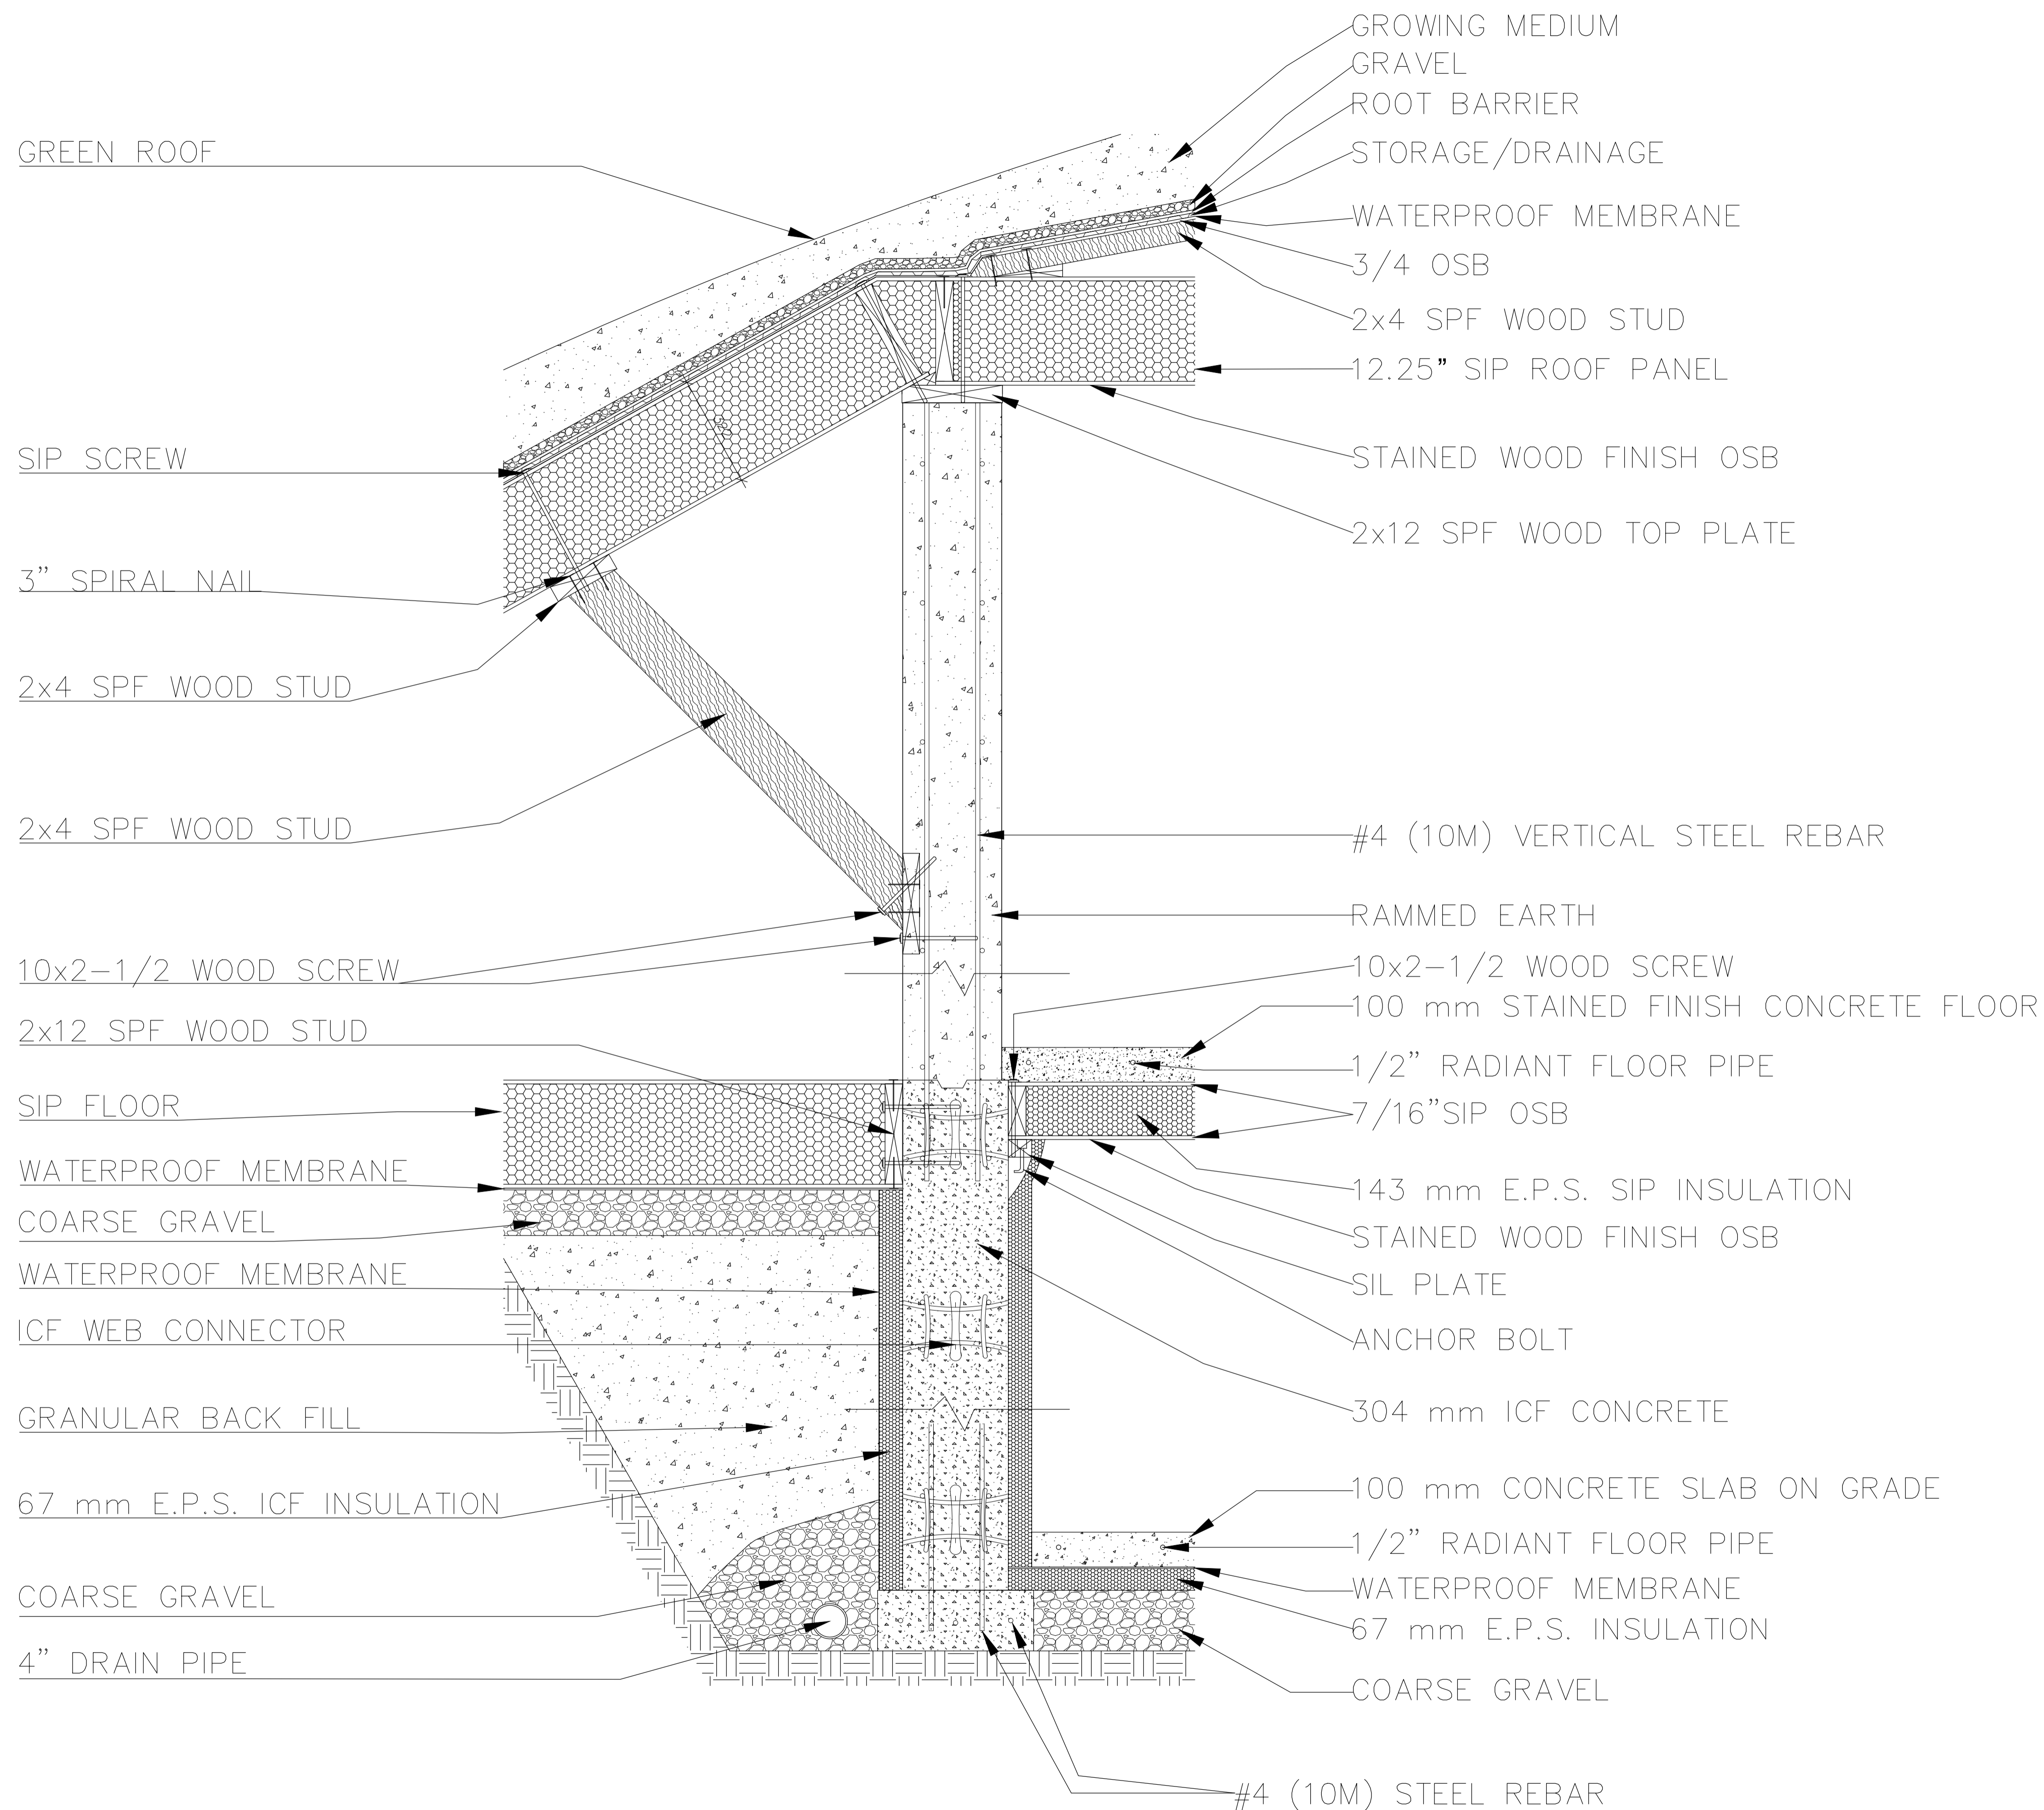

CLIENT/PROJECT  
**SNRG 307**  
**Computer Aided Design 1**  
**House Design Project**

PROJECT SEMESTER PROJECT DATE 13 / 12 / 2012

DRAWN Murat Kinaci APPROVED


SHEET TITLE  
**Partial Section View**

Scale: 1 : 10

SHEET **E-12-13**

PART OF LOT 21  
CONCESSION 7, E.H.S.,  
TOWNSHIP OF MONO  
COUNTY OF DUFFERIN

Scale: 1 : 750

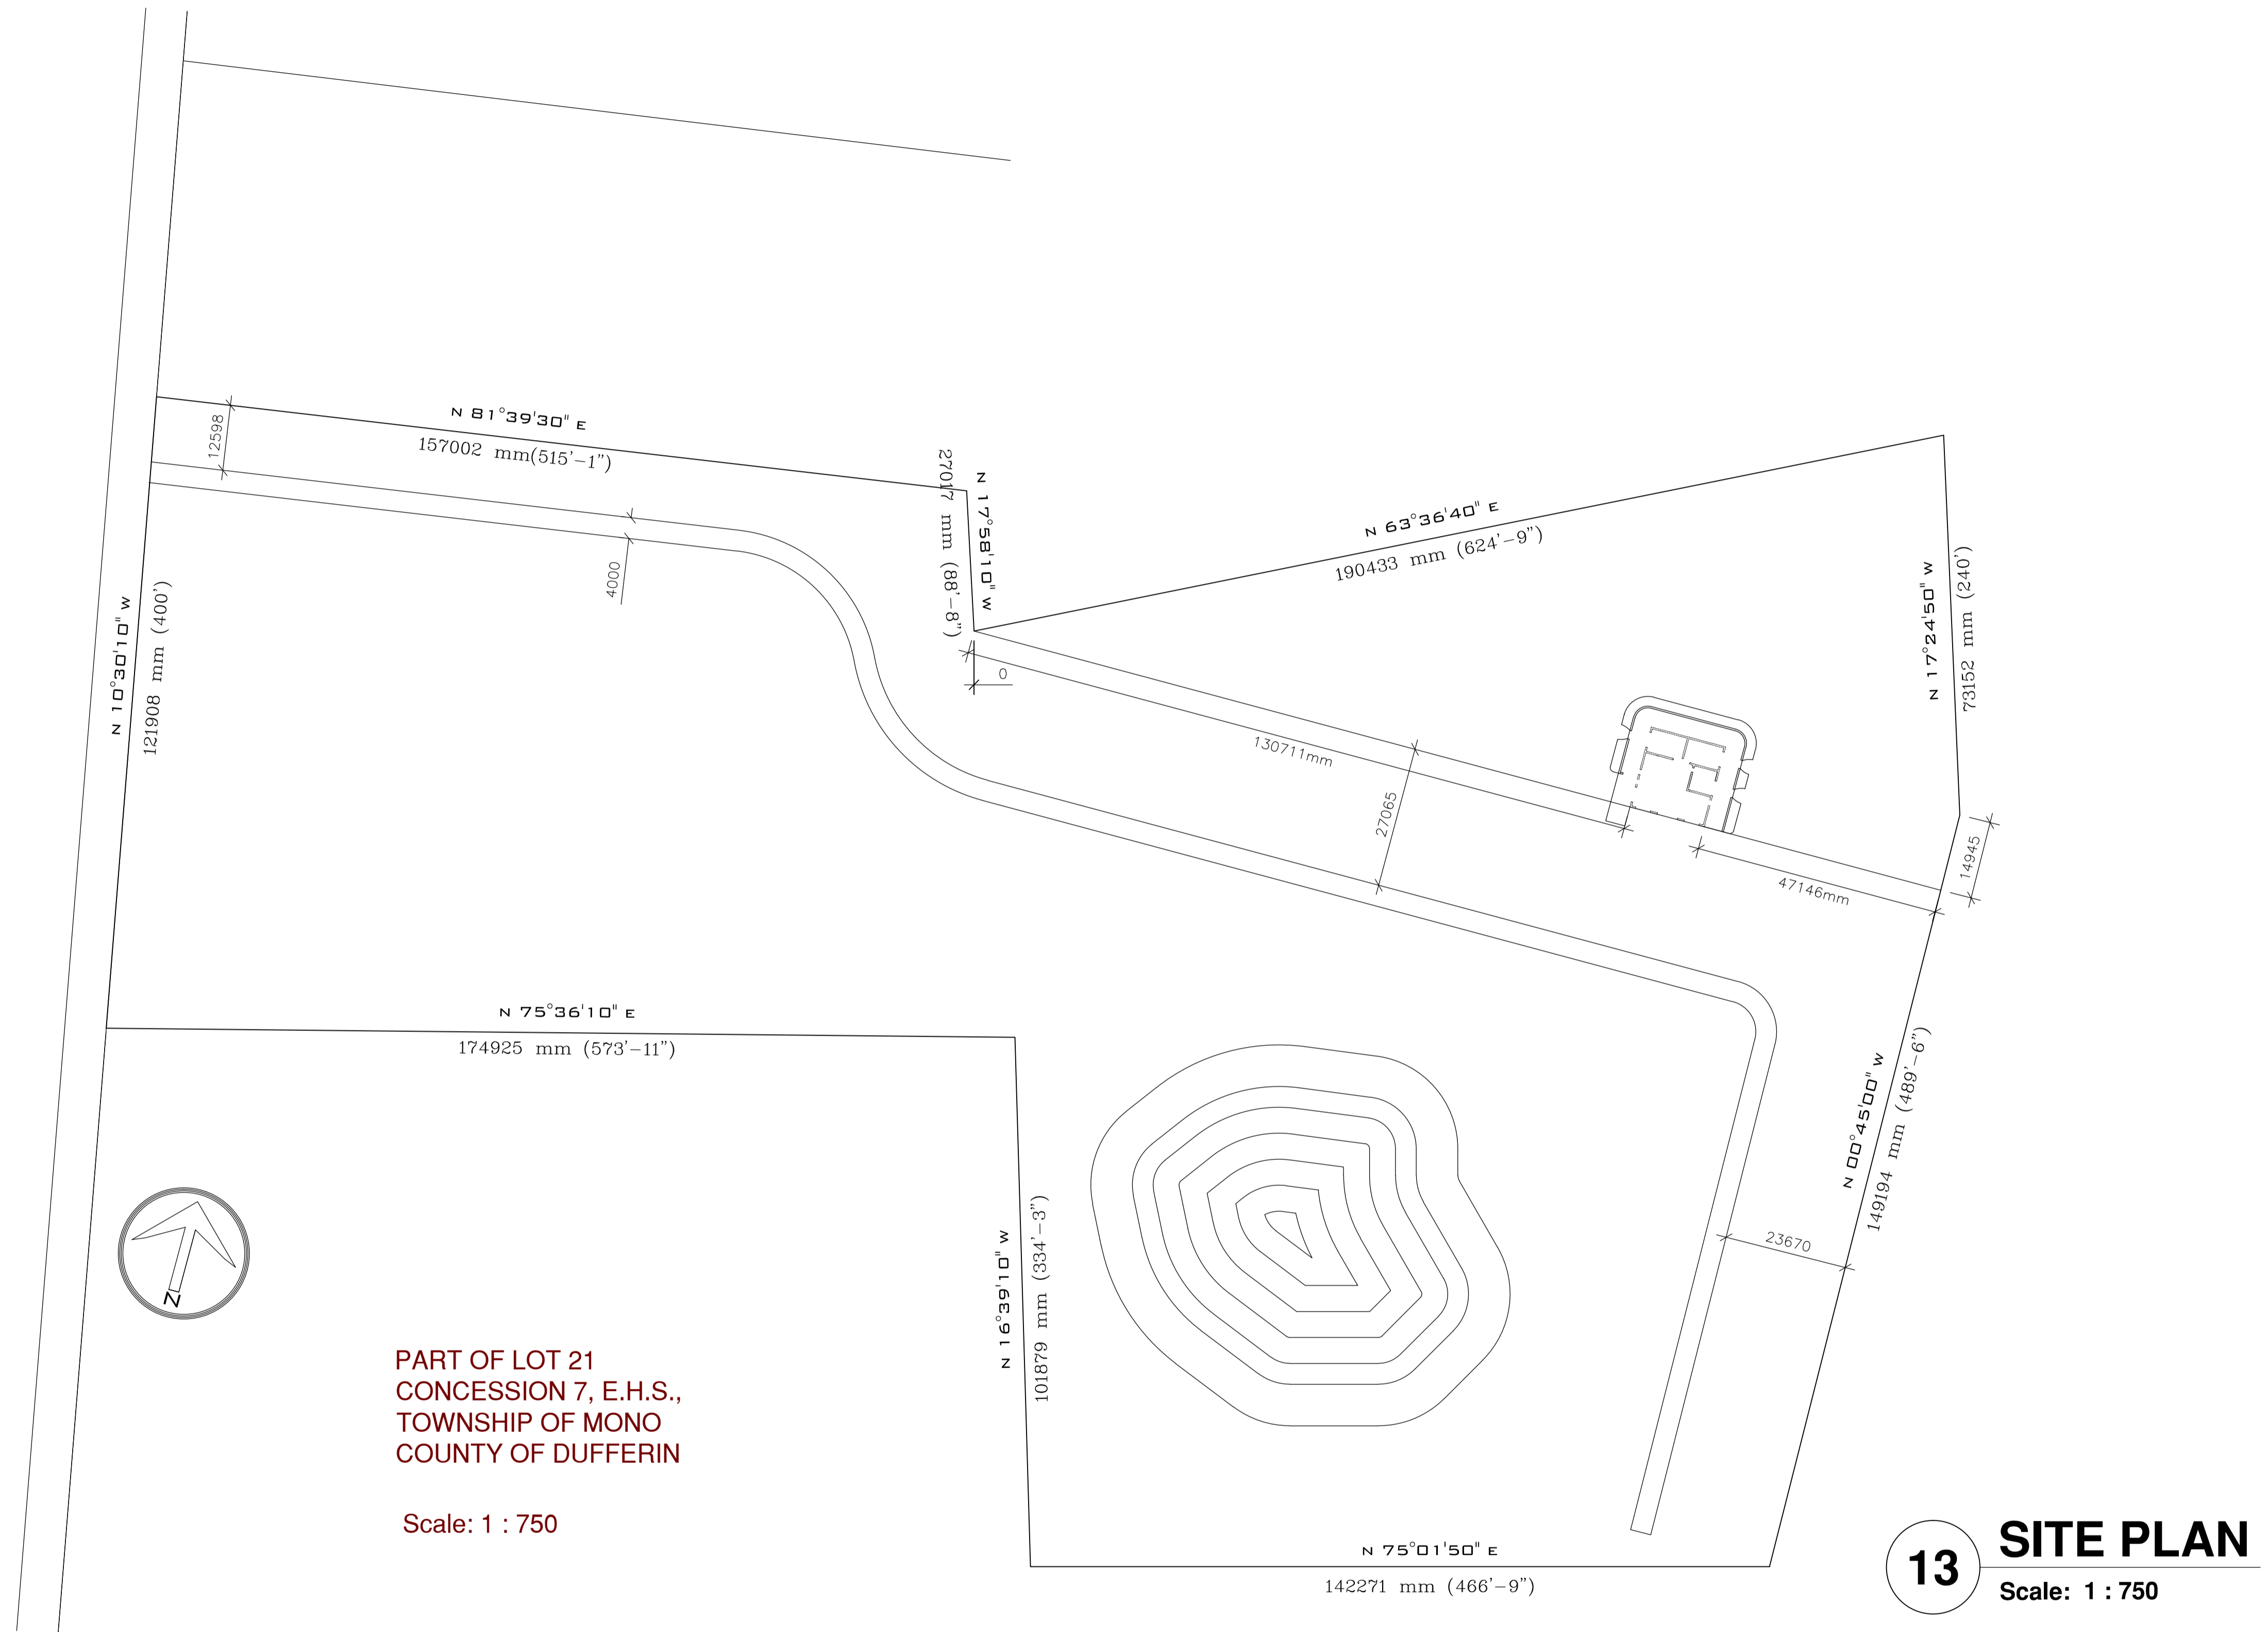

CLIENT/PROJECT

SNRG 307  
Computer Aided Design 1  
House Design Project

PROJECT	DATE
SEMESTER PROJECT	13 / 12 / 2012
DRAWN	APPROVED
Murat Kinaci	

SHEET TITLE

Site Plan

Scale: 1 : 750

SHEET **S-13-13**

WINDOW SCHEDULE								
SYMBOL	UNITS	MFR	TYPE	MODEL#	FINISHED SIZE	REMARKS	U Value	SHGC
W1	3	Inline Fiberglass Ltd.	HORIZONTAL SLIDER	800 SERIES	1900mm x 2945mm	Dual Pane - Low-E / Hard Coat	0.33	0.56
W2	3	Inline Fiberglass Ltd.	SLIDING PATIO DOOR	600 SERIES	1962mm x 1627mm	Dual Pane - Low-E / Hard Coat	0.32	0.54
W3	4	Inline Fiberglass Ltd.	SLIDING PATIO DOOR	600 SERIES	2000mm x 2945mm	Dual Pane - Low-E / Hard Coat	0.32	0.54
W4	1	Inline Fiberglass Ltd.	SLIDING PATIO DOOR	600 SERIES	4000mm x 3570mm	Dual Pane - Low-E / Hard Coat	0.32	0.54
W5	1	Inline Fiberglass Ltd.	SLIDING PATIO DOOR	600 SERIES	1651mm x 2002mm	Dual Pane - Low-E / Hard Coat	0.32	0.54
W6	1	Inline Fiberglass Ltd.	SLIDING PATIO DOOR	600 SERIES	762mm x 524mm	Dual Pane - Low-E / Hard Coat	0.32	0.54

DOOR SCHEDULE						
SYMBOL	UNITS	MFR	TYPE	MODEL#	FINISHED SIZE	REMARKS
D1	3	STANLEY DOORS	Steel Exterior Door	9800BLK-7R	950mm x 2092mm	Energy Star® certified
D2	5	MASONITE	6 Panel Clear Pine Door	171885	813mm x 2032mm	
D3	3	MASONITE	6 Panel Clear Pine Door	171886	762mm x 2032mm	



CLIENT/PROJECT  
**SNRG 307  
Computer Aided Design 1  
House Design Project**

PROJECT DATE  
SEMESTER PROJECT 13 / 12 / 2012

DRAWN  
Murat Kinaci

SHEET TITLE  
**Door and Window  
Schedules**

SHEET  
**A-1**